ZONING BOARD OF APPEALS

Thursday, May 23, 2019

6:00 pm

Council Board Room One Batavia City Centre, Batavia, NY

AGENDA

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I.	1) ~ 1	[Call
	RAH	

- II. Call to order
- III. Pledge of Allegiance
- IV. Approval of March 28, 2019 minutes
- V. Statement about the role of the Zoning Board of Appeals and the procedure it follows
- VI. Variance Requests
 - **A. Request** #1 172 *Pearl St.*

Heather Phillips, owner

Area Variance: <u>Placement of a one-story plastic shed in a yard (east side</u>

yard) other than a rear yard

- 1. Review application
- 2. Public hearing and discussion
- 3. Action by the board

B. Request #2 *52 Cedar St.*

Guy Clark, owner

Area Variance: Construction of a 6,000 sq.' pole-style building on this

undeveloped parcel. The uses will include an area of approximately 900 sq.' for retail sales and 5,100 sq.' for storage and service operations related to the Cedar Street

Sales and Rentals business

- 1. Review application
- 2. Public hearing and discussion
- 3. Action by the board

C. Request #3 43 Vernon Ave.

Charles Kohorst, contractor/agent for owner

Area Variance:

Removal of an existing open porch and construction of a new enclosed front porch with stairs and landing under an existing roof. Portions of the new structure will be located within the front yard clear space

- 1. Review application
- 2. Public hearing and discussion
- 3. Action by the board

VII. Setting of Next Meeting: June 27, 2019

VIII. Adjournment

ZONING BOARD OF APPEALS

Draft Minutes Thursday, March 28, 2019 6:00 pm

Council Board Room One Batavia City Centre, Batavia, NY

Members present: Deborah Kerr-Rosenbeck, Paul McCarthy,

Leslie Moma, Jim Russell

Members absent: Bill Cox, Nick Harris

Others present: Meg Chilano – Recording Secretary, Ron Panek – Code

Enforcement Officer

I. Roll Call

Roll call of the members was conducted. Four members were present and Chairman McCarthy declared a quorum.

II. Call to Order

Mr. McCarthy called the meeting to order at 6:00 pm.

III. Pledge of Allegiance

IV. Approval of Minutes

There were no corrections to the minutes. Mr. McCarthy assumed the motion and the minutes were approved as written by unanimous consent.

RESULT: Approval of February 28, 2019 minutes.

V. Zoning Board of Appeals statement

Mr. McCarthy explained the role of the Zoning Board of Appeals and the procedures it follows.

VI. Variance Request

Area Variance: construction of a 6' x 10' pressure treated wood-frame deck at the front entry of this single-family dwelling to replace an existing 1.9' x 10' concrete patio and stair

Address: 219 East Main St. Applicant: Scott Neff, owner

Actions: 1. Review proposal

2. Public hearing and discussion

3. Action by the board

1. Review Application

Acting Vice Chair Deborah Kerr-Rosenbeck read the summary of the proposal. Mr. McCarthy reported that both the Genesee County Planning Board and the City of Batavia Planning and Development Committee recommended approval of the proposal.

2. Public Hearing and Discussion

MOTION: Mr. McCarthy moved to open the public hearing; the motion was seconded by Mr. Russell, and on roll call, was approved 4-0.

RESULT: Public hearing opened at 6:04 pm.

Mr. Schiavi told the board that the entrance is falling apart, and he wants to fix it and make it look good.

There was no one present who wished to speak about the project, and no phone calls, letters, or emails.

MOTION: Mr. McCarthy moved to close the public hearing; the motion was seconded by Mr. Russell, and on roll call, was approved 4-0.

RESULT: Public hearing closed at 6:06 pm.

3. Action by the Board

Mr. Panek explained that the Code says each entrance must have a level walking surface leading to the door as a minimum requirement. The board members agreed that there is not another option for dealing with the entrance.

Mr. McCarthy went through the list of supporting criteria for the variance:

- Undesirable change in neighborhood character: no
- Alternative cure sought: no
- Substantiality: no
- Adverse effect or impact on neighborhood/community: no
- Self-created: no

MOTION: Ms. Kerr-Rosenbeck moved to approve the proposal with 60 days to obtain the permit. The motion was seconded by Mr. McCarthy, and on roll call, was approved 4-0.

RESULT: Approval of Area Variance.

VII. New Business: none

VIII. Setting of Next Meeting: April 25, 2019

IX. Adjournment

Mr. McCarthy moved to adjourn the meeting at 6:11 pm; Mr. Russell seconded. All voted in favor.

Meg Chilano Bureau of Inspection Secretary



City of Batavia Department of Public Works Bureau of Inspections

One Batavia City Center, Batavia, New York 14020

(585)-345-6345

(585)-345-1385 (fax)

To: Zoning Board of Appeals

Genesee County Planning

From: Doug Randall, Code Enforcement Officer

Date: 4/24/18

Re: 172 Pearl St.

Tax Parcel No. 84.009-1-35

Zoning Use District: R-2

The applicant, Heather Phillips (owner), has filed an application to place a one story molded plastic shed in a yard (east side yard) other than a rear yard.

Note: This is a type II action as defined by Environmental Conservation Law and is not subject to review under SEQR 6 NYCRR Part 617.5 (c) (10).

Review and Approval Procedures:

County Planning Board- Pursuant to General Municipal Law 239 m, referral to the County Planning Board is required since the property is within 500 feet of the right of way of a state road or highway.

Zoning Board of Appeals- Pursuant to BMC Sec. 190-49 of the zoning ordinance, the ZBA shall review and act on required variances.

Required variances- Area

1) BMC 1990-35 D. Accessory buildings are not permitted to occupy spaces other than a rear yard.



GENESEE COUNTY PLANNING BOARD REFERRALS

S G 1 G 2	N	OTICE OF FINAL A	CTION
1802	GCDP Referral ID	C-04-BAT	-5-19
W YOK	Review Date	5/9/	2019
Municipality	BATAVIA, C.		
Board Name	ZONING BOARD OF	APPEALS	
Applicant's Name	Heather Phillips		
Referral Type			
Variance(s)	Area Variance(s)		
Description:	Area Variance to place a	shed in a yard other than	a rear yard.
Location	172 Pearl St. (NYS F	Rt. 33), Batavia	
Zoning District	Residential (R-2) Dis		
PLANNING BOARD			
APPROVAL	DEGIGION		
EXPLANATION:			
The proposed shed should	l pose no significant count	y-wide or inter-community i	mpact. The applicant is limited in
the shed's location due to	the shape of the parcel and	d the adjacent powerline ea	sement.
20			
~ 0 . (7/1			
Folin J. Att	thering		9, 2019

If the County Planning Board disapproved the proposal, or recommends modifications, the referring agency shall NOT act contrary to the recommendations except by a vote of a majority plus one of all the members and after the adoption of a resolution setting forth the reasons for such contrary action. Within 30 days after the final action the referring agency shall file a report of final action with the County Planning Board. An action taken form is provided for this purpose and may be obtained from the Genesee County Planning Department.

SEND OR DELIVER TO:

GENESEE COUNTY DEPARTMENT OF PLANNING 3837 West Main Street Road

Batavia, NY 14020-9404
Phone: (585) 344-2580 Ext. 5467

DEPAR	TMENT USE ONLY:
GCDP Referral # _	



* GENESEE COUNTY * PLANNING BOARD REFERRAL

Required According to:

GENERAL MUNICIPAL LAW ARTICLE 12B, SECTION 239 L, M, N (Please answer ALL questions as fully as possible)

1. REFERRING BOARD(S) INFORMATION	2. <u>Applicant Information</u>			
Board(s) Zoning Board of Appeals	Name Heather Phillips			
Address One Batavia City Centre Address 172 Pearl St.				
City, State, Zip Batavia, NY 14020	City, State, Zip Batavia, NY 14020			
Phone (<u>585</u>) 345 - 6347 Ext. Ph	one (716) 474 - 4372 Ext. Email			
MUNICIPALITY: City Town Vi	llage of Batavia			
3. TYPE OF REFERRAL: (Check all applicable items)				
Special Use Permit Comprehen	Change Subdivision Proposal Amendments Preliminary sive Plan/Update Final			
4. LOCATION OF THE REAL PROPERTY PERTAININ	IG TO THIS REFERRAL:			
A. Full Address 172 Pearl St				
B. Nearest intersecting road Industrial				
C. Tax Map Parcel Number <u>84.009-1-35</u>				
D. Total area of the property Area of property to be disturbed				
E. Present zoning district(s) R-2				
5. <u>REFERRAL CASE INFORMATION:</u> A. Has this referral been previously reviewed by the C	Genesee County Planning Board?			
NO YES If yes, give date and action tak	en			
B. Special Use Permit and/or Variances refer to the fe	ollowing section(s) of the present zoning ordinance and/or law			
BMC 190-35 D				
C. Please describe the nature of this request Approve	I to place a shed in a yard other than a rear yard			
6. ENCLOSURES - Please enclose copy(s) of all appropria	te items in regard to this referral			
☐ Site plan ☐ Location ma ☐ Subdivision plot plans ☐ Elevation di	/map amendments p or tax maps awings data statement New or updated comprehensive plan Photos Cover letter			
If possible, please provide a reduced version or d Email to <u>planning@co.genesee.ny.us</u>	igital copy of any supporting documentation larger than 11 x 17.			
7. CONTACT INFORMATION of the person representing	the community in filling out this form (required information)			
Name Douglas Randall Title Code	Enf. Officer Phone (585) 345 - 6327 Ext.			
Address, City, State, Zip One Batavia City Centre, Batavia	avia, NY 14020 Email drandall@batavianewyork.com			

CITY OF BATAVIA APPLICATION TO THE ZONING BOARD OF APPEALS

			101501	
1915			Application No.: 1900	
Williams.		MAY 2 0 2019	Hearing Date/Time:	
APPLICANT	: Heather P	dillins DATAVIA	hlp9924@yanos.com	- 1
APPLICANT	Name	CLERK-TREASURER	E-Mail Address	
		art St.	716-474-4372	-
	Street Address	,	Phone Fax	
	Batavia		14020	1
	City	State ·	Zip	
STATUS:	. X Owner	Agent for On	vner Contractor	1
OWNER:	Heather	Phillips		1
O WILDIG	Name		E-Mail Address	1
, 1	172 Pearl	54.		- 1
	Street Address		Phone Fax	- 1
	City Batavia	NY State	14020	
363	City	State	Zip	Ί.
LOCATION C	OF PROPERTY:	172 Pearl St.	Pratavia NY 14020	
			Casacta	- [
DETAILED DES	CRIPTION OF REQUES	or: To cellow	a plastic milded	1
Shed	to remain			ı
1	^ ! <			۱
placed	ne sa sa	ackyard's lack	of size due to	- 1
Poux	rline east	ement.	2.9	
the applicant to pr	esent evidence sufficient to	. Failure to do so will result in the a satisfy the Zoning Board of Appeals ral welfare of the community or neig	pplication being discarded. It is the responsibility of s that the benefit of the applicant does not outweigh ghborhood.	
	0 5	•		- 1
11/00	ither Dhill.	~	4/6/19	
Applicant's Si	gnature	η	Date	-
	00		1 1 .	90099000
lileat	het hue	<u> </u>	4/6/19	anderson
Owner's Signa		D	late	OMOUN
	· · · · · · · · · · · · · · · · · · ·	To be Filled out by Zoning Of	fG a.m.	
			gicer	of the same of the
TAX PARCEL	84.009-1-3	ZONING DISTRICT:	FLOOD PLAIN:	
TYPE OF APP	Use Varia	ince	EE:\$50 (One or Two Family Use) \$100 (All other Uses)	.
	Interpreta			
	Decision	of Planning Committee		
Provision(s) of i	the Zoning Ordinance A		-35 D accessory building	gb
aunot	pennito to	Decepy spaces ofth	nthan a nearyard.	٧

Criteria to Support Area Variance

In making its determination, the zoning Board of Appeals shall take into consideration the benefit to the applicant if the variance is granted, as weighed against the detriment to the health, safety, moral, aesthetics and welfare of the neighborhood or community. The Zoning Board of Appeals shall consider the following test, as per §81-b of the General City Law when making its determination:


Explain **how** the proposal conforms to EACH of the following requirements:


1.	Undesirable Change in neighborhood Character. The granting of the variance will not produce an undesirable change in the neighborhood or a detriment to nearby properties. On Side of Nouse with no immediate neighbors
2.	Alternative Cure Sought. There are no other means feasible for the applicant to pursue that would result in the difficulty being avoided or remedied, other than the granting of the area variance. Backgord is small due to power line easement.
3.	Substantiality. The requested area variance is not substantial. 5mall shed
4,	Adverse Effect or Impact. The requested variance will not have an adverse effect or impact on the physical or environmental condition in the neighborhood or community. On the side of the Nouse with no immediate neighbors. Does not block any Diews.
5.	Not Self-Created. The alleged difficulty existed at the time of the enactment of the provision or was created by natural force or governmental action, and was not the result of any action by the owner or the predecessors in title. Pavereusement does not allow room for each a Structure behind the house.
Ā	pplicant's Signature Leathy healer u/6/19 Date

CITY OF BATAVIA

BUILDING PERMIT APPLICATION

DATE: 46 19	
APPLICANT NAME & PHONE: Heather Philli	PS 716-474-4372
	Permit #: Fee:
Address of Project: 172 Pearl Street	
Owner & Address: Heather Phillips 172	Pearl St. Batavia, Ny, 14020
Phone: 716-474-4372	
Duning A Time / Deposition Mark	
Project Type/Describe Work	Suncol gaibhus (
Estimated cost of work: 5 450	Start date: 9 1117
Describe project:	
Premade plastic shed	# 3 ^ 중경화 31시 k
•	syldtiger, som alæinen, and algum an mythe met algumen i en i
Contractor Information – Insurance certificates (liab	ility & workers comp) required being on file
GENERAL	
Name/Address:	page of surject the property of the early the
Phone:	den len luce lang englig yers i pla engle edit sego
PLUMBING (City of Batavia Licensed Plumber Requ	ired)
Name/Address:	Assume a substruction of the section
Phone:	arcka lovo sinoresouper salve list at a significate p.
<u>HEATING</u>	the transfer with the control of account the control of the contro
Name/Address:	
Phone:	
ELECTRICAL (Third Party Electrical Inspection	
Name/Address:	• • • • • • • • • • • • • • • • • • • •
Phone:	
mass more explicitly and constraint	e projetti maa ee e
	E USE ONLY
Zoning District: Flood Zone: Corner Lo	
Zoning Review: Variance Required: Site P	
National Grid Sign Off (Pools):	Lot Size:
	ing Code Occupancy Class:
Proposed Use: NYS Buildi	ng Code Occupancy Class:

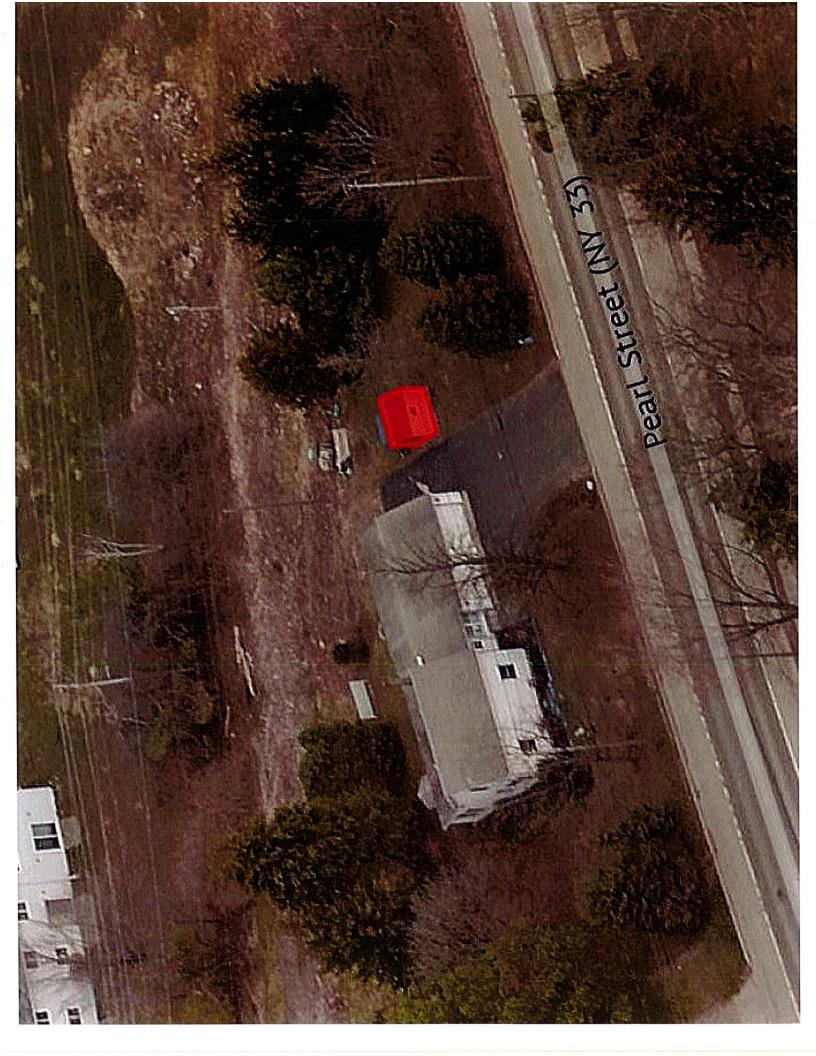

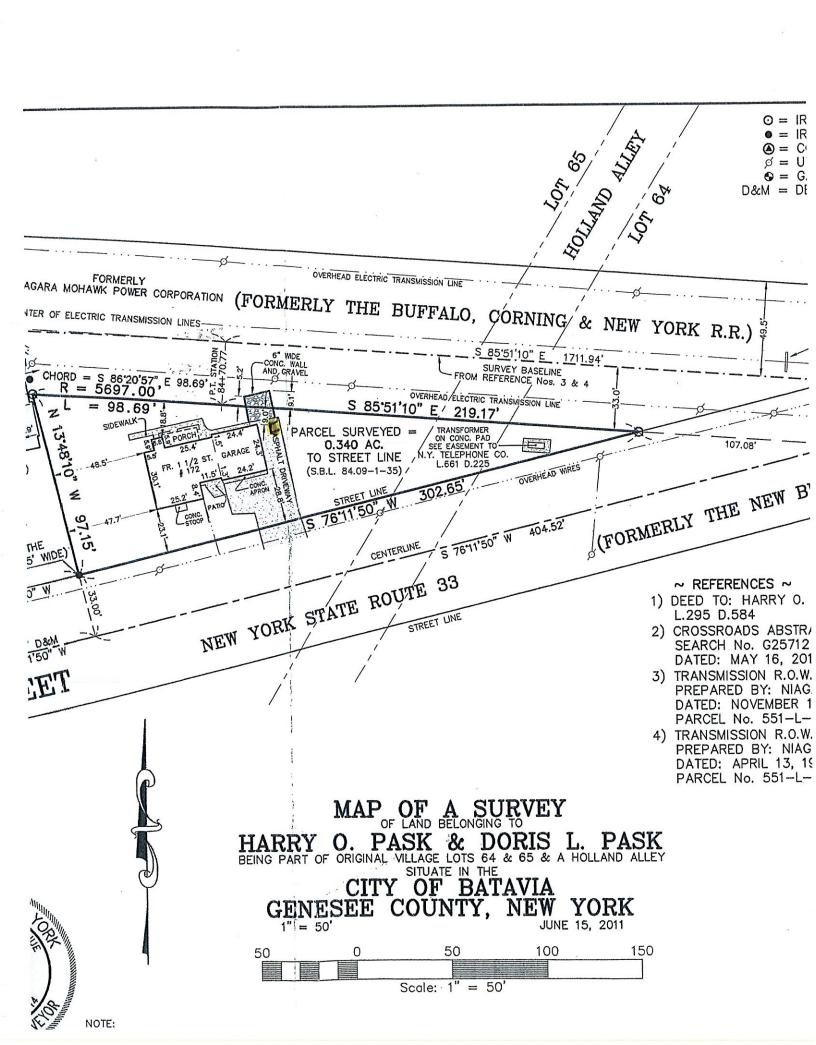



GENESEE COUNTY PLANNING BOARD REFERRALS

S GHAD 2	NOTICE OF FINAL ACTION	
1802	GCDP Referral ID C-03-BAT-5-19	
W YOR		
900000000000000000000000000000000000000		
Municipality	BATAVIA, C.	
Board Name	CITY PLANNING AND DEVELOPMENT/ZBA COMM.	
Applicant's Name	Guy Clark	
Referral Type	Site Plan Review	
Variance(s)	Area Variance(s)	
Description:	Site Plan Review and Area Variance to construct a 6,000 sq. ft. (60 x 100 ft.) building for retail sales and inventory for an adjacent business (Cedar Street Sales and Rentals).	
	Parking in front of the building is not allowed.	
	52 Cedar St., Batavia	
Location	Industrial (I-2) District	
Zoning District		
PLANNING BOARD	DECISION	
APPROVAL		
]		
EXPLANATION:		
patterns, the proposed bu	g parking in the front of the property and that adjacent businesses exhibit similar parking ilding and variance should pose no significant county-wide or inter-community impact. buffer should mitigate any impacts on the adjacent residence.	

May 9, 2019

If the County Planning Board disapproved the proposal, or recommends modifications, the referring agency shall NOT act contrary to the recommendations except by a vote of a majority plus one of all the members and after the adoption of a resolution setting forth the reasons for such contrary action. Within 30 days after the final action the referring agency shall file a report of final action with the County Planning Board. An action taken form is provided for this purpose and may be obtained from the Genesee County Planning Department.



City of Batavia Department of Public Works Bureau of Inspections

One Batavia City Center, Batavia, New York 14020

(585)-345-6345

(585)-345-1385 (fax)

To:

Genesee County Planning

Planning and Development Committee

Zoning Board of Appeals

From:

Doug Randall, Code Enforcement Officer

Date:

4/29/19

Re:

52 Cedar St.

Tax Parcel No. 84.020-1-9

Zoning Use District: I-2

The applicant, Guy Clark (owner), has filed an application to construct a 6,000 square foot pole style building on this undeveloped parcel. The uses will include an area of approximately 900 square feet for retail sales and 5,100 square feet for storage and service operations related to the Cedar Street Sales and Rentals business.

Review and Approval Procedures:

County Planning Board- Pursuant to General Municipal Law 239 m, referral to the County Planning Board is required since the property is within 500 feet of the boundary of a County or State park or other recreation area.

City Planning and Development Committee— Pursuant to section 190-44 C. (1)(a) of the zoning ordinance, the Planning and Development Committee shall perform a site plan review of applications for new buildings that increase the lot coverage by more than 1,300 square feet.

Zoning Board of Appeals- Pursuant to BMC Sec. 190-49 of the zoning ordinance, the ZBA shall review and act on required variances.

Required variances- Area

1) BMC 190-39 B(a) Parking shall be located behind or to the side of the principal building. The plan indicates parking across the front of the building.

The PDC will conduct the uncoordinated review of SEQR.

SEND OR DELIVER TO:

GENESEE COUNTY DEPARTMENT OF PLANNING 3837 West Main Street Road Batavia, NY 14020-9404

Phone: (585) 344-2580 Ext. 5467

	DEPARTMENT USE ONLY:	
GCDP R	eferral #	



* GENESEE COUNTY * PLANNING BOARD REFERRAL

Required According to:

GENERAL MUNICIPAL LAW ARTICLE 12B, SECTION 239 L, M, N
(Please answer ALL questions as fully as possible)

1. REFERRING BOARD(S) INFORMATION 2. APPLICANT INFORMATION				
Board(s) PDC and ZBA Name Guy Clark				
Address One Batavia City Centre Address 111 Cedar St.				
City, State, Zip Batavia, NY 14020 City, State, Zip Batavia, NY 14020				
Phone (585) 345 - 6347 Ext. Phone (585) 343 - 4899 Ext. Email				
MUNICIPALITY: City				
3. TYPE OF REFERRAL: (Check all applicable items)				
Area Variance				
4. LOCATION OF THE REAL PROPERTY PERTAINING TO THIS REFERRAL:				
A. Full Address 52 Cedar St.				
B. Nearest intersecting road Florence				
C. Tax Map Parcel Number 84.020-1-9				
D. Total area of the property .98 acres Area of property to be disturbed				
E. Present zoning district(s) 1-2				
5. REFERRAL CASE INFORMATION: A. Has this referral been previously reviewed by the Genesee County Planning Board?				
■ NO YES If yes, give date and action taken				
B. Special Use Permit and/or Variances refer to the following section(s) of the present zoning ordinance and/or law				
BMC 190-39 B (a) Parking				
C. Please describe the nature of this request Approval to construct a 6,000 sq.' building for retails sales and storage				
6. ENCLOSURES - Please enclose copy(s) of all appropriate items in regard to this referral				
■ Local application Zoning text/map amendments New or updated comprehensive plan ■ Site plan Location map or tax maps Photos Subdivision plot plans Elevation drawings Other: Cover letter ■ SEQR forms Agricultural data statement				
If possible, please provide a reduced version or digital copy of any supporting documentation larger than 11 x 17. Email to <u>planning@co.genesee.ny.us</u>				
7. CONTACT INFORMATION of the person representing the community in filling out this form (required information)				
Name Douglas Randall Title Code Enf. Officer Phone (585) 345 - 6327 Ext.				
Address, City, State, Zip One Batavia City Centre, Batavia, NY 14020 Email drandall@batavianewyork.com				



CITY OF BATAVIA APPLICATION TO THE ZONING BOARD OF APPEALS

Application No.: 19-05
Hearing Date/Time:

No continues of the second			Hearing Dat	e/Time:
APPLICANT	: Guy Clark		10000	
(pa	Name III Cedar St.		E-Mail Addre 343 - 48	
	Street Address		Phone	Fax
	Paravia	44		14050
	City	State ·		Zip ·
STATUS:	Owner	Agent for Owner		Contractor
OWNER:	Name	MANALES AND		
			E-Mail Addres	98 ·
	Street Address		Phone .	Fax
	City	State		Zip ,
LOCATION C	of property: 52 (edar St.		
200	and the second s	a California de la companya del la companya de la c		
Applicant must be the applicant to pro	present at the hearing date. Failure to de sent evidence sufficient to satisfy the Zonorals, aesthetics and general welfare of	o so will result in the applications Roard of Appeals that	ion being disearch	and the instrument of the control of
		·	1.010	
Mann	MANUAL -	- 3/-	29/19	grange, alleges and distributed in the state of the state
Applicant & Sig	nature	Date	/ .	-
× M	a Augus		29/19	ŕ
Owner's Signa	ture Cros	Dafe		
	To be Elle	double 7 to Office		
m i m i de i m mana	-	d out by Zoning Officer		
TAX PARCEL:	84.030-1-9 ZON	ING DISTRICT: 1-3	F	LOOD PLAIN:
ТҮРЕ ОF АРРЕ	Area Variance Use Variance Interpretation Decision of Planning (FEE: Committee	\$50 (One \$100 (All	or Two Family Use) other Uses)
Provision(s) of 11	he Zoning Ordinance Appealed:	BMC 190-39 B	(a) Par	king shall be located
<u> </u>	to the side of the p	civerban Dringin	3. 	PAID
9850				

APR 3 0 2019

CITY OF BATAVIA CLERK-TREASURER

Criteria to Support Area Variance

In making its determination, the zoning Board of Appeals shall take into consideration the benefit to the applicant if the variance is granted, as weighed against the detriment to the health, safety, moral, aesthetics and welfare of the neighborhood or community. The Zoning Board of Appeals shall consider the following test, as per §81-b of the General City Law when making its determination:

Explain how the proposal conforms to EACH of the following requirements:

1.	Undesirable Change in neighborhood Character. The granting of the variance will not
	produce an undesirable change in the neighborhood or a detriment to nearby properties.
	The building will be lickted approximately wo from room
	and should not have negative impact an neighbor head,
2.	Alternative Cure Sought. There are no other means feasible for the applicant to pursue
	that would result in the difficulty being avoided or remedied, other than the granting of the
	area variance. Lue to site configuration, we are lighted
	ca where we can locate for King and still praintein
	- com for work wellstorves
3.	Substantiality. The requested area variance is not substantial. Tarking is for
	enty few spaces, and is located 100'+ from road and
	Besind fede a
4,	Adverse Effect or Impact. The requested variance will not have an adverse effect or
	impact on the physical or environmental condition in the neighborhood or community.
	The four parking spaces located in front of building
	note how here any impact on continument or
	The state of the s
5.	Not Self-Created. The alleged difficulty existed at the time of the enactment of the provi-
	sion or was created by natural force or governmental action, and was not the result of any
	action by the owner or the predecessors in title. Requested change is
	serves of preserves configuration, filmen mins ancinatives
	// //
	An has I follow
Ár	plicant's Signature Date
-1-	Dato

Short Environmental Assessment Form Part 1 - Project Information

Instructions for Completing

Part 1 – Project Information. The applicant or project sponsor is responsible for the completion of Part 1. Responses become part of the application for approval or funding, are subject to public review, and may be subject to further verification. Complete Part 1 based on information currently available. If additional research or investigation would be needed to fully respond to any item, please answer as thoroughly as possible based on current information.

Complete all items in Part 1. You may also provide any additional information which you believe will be needed by or useful to the lead agency; attach additional pages as necessary to supplement any item.

Part 1 – Project and Sponsor Information				
Name of Action or Project:		-	-	
Cedar Street Sales Retail/storage Building				
Project Location (describe, and attach a location map):	\$ \$ \$ \$ \$ \$ \$ \$ \$ \$ \$ \$ \$ \$ \$ \$ \$ \$ \$			
151 Cedar Street, City of Batavia, location map provided in submitted plans				
Brief Description of Proposed Action:				
Proposal is to construct 60ft x 100ft pole barn type building for use as retail sales and inve Majority of building will not be conditioned, only restroom is proposed to be conditioned at t	ntory storage. Project will including time.	de concret	te loading	dock.
Name of Applicant or Sponsor:	Telephone: (585) 297 - 3	552		
Andrew Schmieder	E-Mail: ads60@verizon.r	net		
Address:				
11142 Alexander Road				
City/PO:	State:	Zip Co	de:	
Attica	NY	14011		
1. Does the proposed action only involve the legislative adoption of a plan, lo administrative rule, or regulation?	cal law, ordinance,		NO	YES
If Yes, attach a narrative description of the intent of the proposed action and the	environmental resources th	at	$\overline{\mathbf{V}}$	
may be affected in the municipality and proceed to Part 2. If no, continue to qu			V	Ш
2. Does the proposed action require a permit, approval or funding from any of If Yes, list agency(s) name and permit or approval:	her government Agency?		NO	YES
if it is, not agency(s) hame and permit of approval.			V	
3. a. Total acreage of the site of the proposed action?	0.98 acres			
b. Total acreage to be physically disturbed? c. Total acreage (project site and any contiguous properties) owned	0.30 acres			
or controlled by the applicant or project sponsor?	2.28 acres			
4. Check all land uses that occur on, are adjoining or near the proposed action:				
5. Urban Rural (non-agriculture) Industrial Commercial	cial 🛛 Residential (subur	·ban)		
Forest Agriculture Aquatic Other(Sp	ecify):			
Parkland				

	NO	YES	N/A
a. A permitted use under the zoning regulations?			
b. Consistent with the adopted comprehensive plan?			
6. Is the proposed action consistent with the predominant character of the existing built or natural landscape	??	NO	YES
7. Is the site of the proposed action located in, or does it adjoin, a state listed Critical Environmental Area? If Yes, identify:		NO	YES
8. a. Will the proposed action result in a substantial increase in traffic above present levels?		NO	YES
 b. Are public transportation services available at or near the site of the proposed action? c. Are any pedestrian accommodations or bicycle routes available on or near the site of the proposed 	 		
action? 9. Does the proposed action meet or exceed the state energy code requirements?		NO	YES
If the proposed action will exceed requirements, describe design features and technologies:			TES V
10. Will the proposed action connect to an existing public/private water supply? If No, describe method for providing potable water:		NO	YES
Will the proposed action connect to existing wastewater utilities? If No, describe method for providing wastewater treatment:		NO	YES
2. a. Does the project site contain, or is it substantially contiguous to, a building, archaeological site, or district which is listed on the National or State Register of Historic Places, or that has been determined by the Commissioner of the NYS Office of Parks, Recreation and Historic Preservation to be eligible for listing on the State Register of Historic Places?	}-	NO	YES
b. Is the project site, or any portion of it, located in or adjacent to an area designated as sensitive for rchaeological sites on the NY State Historic Preservation Office (SHPO) archaeological site inventory?		V	
3. a. Does any portion of the site of the proposed action, or lands adjoining the proposed action, contain wetlands or other waterbodies regulated by a federal, state or local agency?		NO V	YES

14. Identify the typical habitat types that occur on, or are likely to be found on the project site. Check all that apply:		
Shoreline Forest Agricultural/grasslands Early mid-successional		
☐ Wetland ☑ Urban ☐ Suburban		
15. Does the site of the proposed action contain any species of animal, or associated habitats, listed by the State or Federal government as threatened or endangered?	NO	YES
receial government as infrateried or endangered?	V	
16. Is the project site located in the 100-year flood plan?	NO	YES
	V	
17. Will the proposed action create storm water discharge, either from point or non-point sources?	NO	YES
If Yes,		V
a. Will storm water discharges flow to adjacent properties?	\checkmark	
b. Will storm water discharges be directed to established conveyance systems (runoff and storm drains)?		V
If Yes, briefly describe: Roof runoff will be directed to drainage		
swale located west of property		
18. Does the proposed action include construction or other activities that would result in the impoundment of water	NO	MEG
or other liquids (e.g., retention pond, waste lagoon, dam)?	NO	YES
If Yes, explain the purpose and size of the impoundment:	1	П
	-	L
19. Has the site of the proposed action or an adjoining property been the location of an active or closed solid waste management facility?	NO	YES
If Yes, describe:		_
20. Has the site of the proposed action or an adjoining property been the subject of remediation (ongoing or	NO	YES
completed) for hazardous waste?	NO	163
If Yes, describe:		П
		
I CERTIFY THAT THE INFORMATION PROVIDED ABOVE IS TRUE AND ACCURATE TO THE BE MY KNOWLEDGE	ST OF	
	116	
Applicant/sponsor/name: And reply Schmiede Date: 4/26	///	
Signature:		






CEDAR STREET SALES AND RENTAL

52 111 CEDAR SREET, BATAVIA, NY

RETAIL/STORAGE BUILDING

	SHEET INDEX					
DWG. NO.	DESCRIPTION	SHEET NO.	RE	NSIONS		
			xx/xx/xx	xx/xx/xx	xx/xx/xx	
			\triangle	A	3	
T-1	TITLE SHEET	1 OF 16				
N-1	CODE COMPLIANCE	2 OF 16				
N-2	GENERAL NOTES	3 OF 16				
C-1	EXISTING SITE LAYOUT	4 OF 16				
C-2	PROPOSED SITE LAYOUT	5 OF 16				
C-3	SITE DETAILS	6 OF 16				
S-1	BUILDING LAYOUT	7 OF 16				
S-2	EAST/WEST WALL FRAMING	8 OF 16				
S-3	ELEVATION/SECTION	9 OF 16				
S-4	STRUCTURAL DETAILS	10 OF 16				
S-5	ROOF FRAMING PLAN	11 OF 16				
F-1	FOUNDATION LAYOUT/DETAILS	12 OF 16				
F-2	LOADING DOCK LAYOUT	13 OF 16				
E-1	ELECTRICAL PLAN	14 OF 16				
E-2	ELECTRICAL DETAILS	15 OF 16			L	
M-1	MECH / PLUMBING PLAN	16 OF 16				

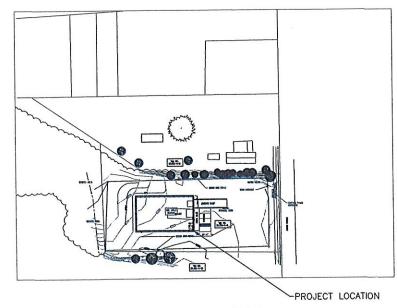

PROJECT LOCATION

SUMMARY OF WORK:

THE FOLLOWING REPRESENTS THE BASIC SCOPE OF WORK:

1. CONSTRUCT 60FT X 100FT POLE BARN TYPE WOOD

Dig Safely. New York

800-962-7962

- ☐ Call Before You Dig☐ Wait The Required Time
- Confirm Utility Response Respect the Marks

www.digsafelynewyork.org

Dig With Care

STRUCTURE TO BE USED FOR RETAIL AND MATERIAL STORAGE. ONLY BATHROOM AREA WILL BE CONDITIONED. ELECTRIC SERVICE TO BE PROVIDED TO STRUCTURE ALONG WITH FIRE ALARM NOTIFICATION DEVICES.

CONTACT INFORMATION:

OWNER: CEDAR STREET SALES: GUY CLARK PH; (585) 409-0395

GENERAL CONTRACTOR: DAN KELLY PH; (716)-560-0331

BUILDING INSPECTOR: CITY OF BATAVIA DOUG RANDALL PH; (585) 343-1729

ENGINEER: ANDREW SCHMIEDER, PE PH: (585) 297-3552

CERTIFICATIONS

- TO THE BEST OF MY KNOWLEDGE AND UNDERSTANDING THE DRAWINGS CONVEYED ON THESE CONSTRUCTION DOCUMENTS COMPLY WITH THE BUILDING CODE OF NEW YORK STATE, 2015 EDITION, AND ALL PURSUANT DOCUMENTS.
- 2. TO THE BEST OF MY KNOWLEDGE AND UNDERSTANDING THE DRAWINGS CONVEYED ON THESE CONSTRUCTION DOCUMENTS COMPLY WITH THE ENERGY CONSERVATION CONSTRUCTION CODE OF NEW YORK STATE, 2015 EDITION, INCLUDING ADDITIONAL INSULATION PROVIDED BY OTHERS.

	PLANS	ISSUED	FOR:
X	PRELIMINARY	DATE:	04/14/19
O	REVIEW	DATE:	
X	PERMIT	DATE:	04/24/19
	REVISIONS	DATE:	
	AS-BUILTS	DATE:	
n	CONSTRUCTION	ON DATE:	

PROJECT MANAGER: ANDREW SCHMIEDER

UNAUTHORIZED ALTERATION OR ADDITION TO THIS DRAWING IS A VIOLATION OF NEW YORK STATE EDUCATION LAW ARTICLE 145, SECTION 7209				DESCRIPTION	REVISIONS
INAUTHORIZED ALTERATI IEW YORK STATE EDUCA	3	2	-	NO. DATE:	



ANDREW SCHMIEDER,PE

STORAGE / RETAIL BUILDING
111 CEDAR ST., BATAVIA, IV CEDAR STREET SALES


PROJECT NO.: 005-2019	PROJ. MGR ADS
DATE: 4-3-19	DRWN. BY:
SCALE: AS NOTED	CHKD. BY:
DRAWING NO: T-1	
SHEET NO.	of 16


	310	JRAGE B	UILDING	CODE COMPLIANC	, C		
ПЕМ	SECTION	REQ'D/ALLOW'D	PROPOSED	ПЕМ	SECTION	REQ'D/ALLOW'D	PROPOSED
CLASSIFICATION & DESIGN				STRUCTURAL REQUIREMENTS			
OCCUPANY GROUP	CHAPTER 3	М	М	BLDG CLASS/SEISMIC USE GRP	TABLE 1604.5	11	II
ACCESSORY USE AREAS	SECTION 302.2	< %10	< %10	MAXIMUM FLOOR LIVE LOAD	TABLE 1607.1	VEH.WT.	VEH WT
SPECIAL USE & OCCUPANCY	CHAPTER 4	NA/MINOR SERVICE	NA	ROOF LIVE LOAD	SECTION 1607.12	20 PSF	20 PSF
BUILDING AREA	CHAPTER 5		-	GROUND SNOW LOAD	FIGURE 1608.1	50 PSF	50 PSF
SPRINKLER INCREASE	SECTION 506	NA	NA	ROOF SNOW LOAD (Pf)	SECTIONS 1608.1	40 PSF	40 PSF
FRONTAGE INCREASE	SECTION 506	NA	NA	SNOW LOAD IMP. FACTOR	ASCE-7	1.0	1.0
BUILDING HEIGHT	TABLE 504.3	65'	25'	SNOW EXPOSURE FACTOR	ASCE 7	0.9	0.9
ALLOW AREA	SECTION 506.2	9,000	6,000	THERMAL FACTOR FACTOR	ASCE-7	1.2	1.2
NUMBER OF STORIES	TABLE 504.4	1	1	BASIC WIND SPEED	FIGURE 1609	115 MPH	115 MPH
				EQUIVALENT WIND SPEED	TABLE 1609.3.1	89 MPH	89 MPH
CONSTRUCTION TYPE	CHAPTER 6	ANY	TYPE VB	MAX. WIND LOAD	TABLE 1609.6	18 PSF	18 PSF
FIRE RESISTANCE RATING	TABLE 602	0	0	FLOOD LOAD	SECTION 1612	NA NA	NA
FIRE SAFETY FEATURES				SITE CLASS	ASCE 7	D	D
FIRE WALLS	SECTION 706	NA NA	NA	SEISMIC DESIGN CATEGORY	ASCE 7	В	В
FIRE BARRIERS	SECTION 706	NA NA	1HR	SEISMIC MAPPING FACTORS			
FIRE PARTITIONS	SECTION 708/1004.3.2.1	NA NA	NA	SS	FIGURE 1613 (1)	0.2	04
AUTOMATIC SPRINKLER SYSTEM	SECTION 903.2.9	NA .	NA	S ₁	FIGURE 1613 (2)	0.0	62
				FIRE RESISTANCE RATINGS			
FIRE EXTINGUISHERS	NYSFC SECTION 906	3	3	STRUCTURAL FRAME	TABLE 601	0	0
FIRE & SMOKE DETECTION	SECTION 907	NR	Y	INTERIOR BEARING WALLS	TABLE 601	0	0
FIRE ALARM SYSTEM	SECTION 907	NR	Y	EXTERIOR BEARING WALLS	TABLE 601	0	0
				INTERIOR NON-BEARING WALLS	TABLE 602	0	0
MEANS OF EGRESS				EXTERIOR NON-BEARING WALLS	TABLE 602	0	0
TOTAL OCCUPANT LOAD	TABLE 1004.1.1	20	2	FLOOR CONSTRUCTION	TABLE 601	0	0
MIN. TTL. EGRESS WIDTH-STAIR	SECTION 1011	NA	NA	ROOF CONSTRUCTION	TABLE 601	0	0
MIN. TTL. EGRESS WIDTH-OTHER	SECTION 1005.1	0.2X12 = 4"	36"	FIRE WALLS	TABLE 706.4	NA NA	NA
ACCESSIBLE MEANS OF EGRESS	SECTION 1007	YES - 2	YES - 1	VERTICAL EXIT ENCLOSURE	SECTION 1020	NA NA	NA
MIN. EGRESS DOOR WIDTH	SECTION 1010	32" CLEAR	36° CLEAR	EXIT PASSAGEWAY	SECTION 1021	NA NA	NA
MIN. EGRESS STAIR WIDTH	SECTION 1011	NA NA	NA	INCIDENTAL USE AREAS	TABLE 508.2	N/A	N/A
MIN. EGRESS RAMP WIDTH	SECTION 1012	NA NA	NA	OCCUPANCY SEPARATION	TABLE 508.3.3	NA NA	NA
MAX. EXIT ACCESS TRAVEL	TABLE 1017	200'	60'	CORRIDORS	SECTION 1017	NA	NA
MIN. EGRESS CORRIDOR WIDTH	SECTION 1020	NA NA	NA	ACCESSIBILITY			
MIN. NUMBER OF EXITS	SECTION 1022	2	2	VERTICAL ACCESS	SECTION 1104.4	· NA	NA
	 	 	·	PARKING	TABLE 1106.1	4	4

NA - NOT APPLICABLE // NC - NON-COMBUSTIBLE // C - COMBUSTIBLE // NR - NOT REQUIRED

			UIREMENTS, R-VALUE METHOD	
		TABLE C402.1.3		
LABEL	DESCRIPTION	VALUE	COMMENTS	
1	CLIMATE ZONE	5A		
2	ATTIC AND OTHER	R-38		
3	WALLS ABOVE GRADE—WOOD FRAMED AND OTHER	R-13 + R-3.8CI OR, R-20		
4	WALLS BELOW GRADE	R-7.5Cl		
5	FLOORS-JOIST FRAMING	R-30		
6	SLAB ON GRADE - UNHEATED SLAB	R-10 FOR 24" BELOW		

ONLY THE BATHROOM AREA IS TO BE CONDITIONED

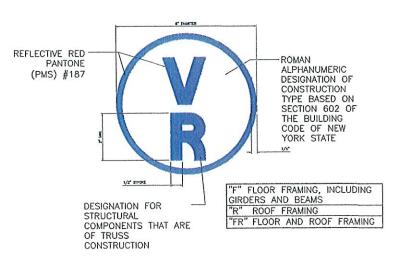

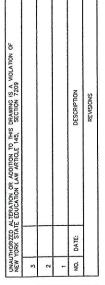



ANDREW SCHMIEDER, PE

LIANCE	IL BUILDING atavia, ny	ET SALES BATAWA, NY
DRAWING TITLE: CODE COMPLIANCE	PROJECT NAME: STORAGE / RETAIL BUILDING 111 CEDAR ST., BATAWA, NY	CEDAR STREET SALES
DRAWIN	PROJEC	CLIENT:

PROJECT NO.: 005-2019	PROJ. MGR.
DATE: 4-3-19	DRWN. BY:
SCALE: AS NOTED	CHKD. BY:
DRAWING NO: N-1	
SHEET NO.	
2	of 16


ITEM	SECTION	REQ'D/ALLOW'D	PROPOSED	ITEM	SECTION	REQ'D/ALLOW'D	PROPOSED
CLASSIFICATION: & DESIGN				STRUCTURAL REQUIREMENTS			
OCCUPANY GROUP	CHAPTER 3	М	М	BLDG CLASS/SEISMIC USE GRP	TABLE 1604.5	11	11
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SPECIAL USE & OCCUPANCY	CHAPTER 4	NA/MINOR SERVICE	NA NA	ROOF LIVE LOAD	SECTION 1607.12	20 PSF	20 PSF
BUILDING AREA	CHAPTER 5			GROUND SNOW LOAD	FIGURE 1608.1	50 PSF	50 PSF
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FIRE WALLS	SECTION 706	NA	NA	SEISMIC DESIGN CATEGORY	ASCE 7	В	В
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FIRE PARTITIONS	SECTION 708/1004.3.2.1	NA NA	NA	SS	FIGURE 1613 (1)	0.2	04
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				FIRE RESISTANCE RATINGS			
FIRE EXTINGUISHERS	NYSFC SECTION 906	3	3	STRUCTURAL FRAME	TABLE 601	0	0
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MIN. EGRESS RAMP WIDTH	SECTION 1012	NA NA	NA NA	OCCUPANCY SEPARATION	TABLE 508.3.3	NA	NA NA
MAX. EXIT ACCESS TRAVEL	TABLE 1017	200'	60'	CORRIDORS	SECTION 1017	NA	NA
MIN. EGRESS CORRIDOR WIDTH	SECTION 1020	NA NA	NA NA	ACCESSIBILITY			
MIN. NUMBER OF EXITS	SECTION 1022	2	2	VERTICAL ACCESS	SECTION 1104.4	NA	NA
			-	PARKING	TABLE 1106.1	4	4

NA - NOT APPLICABLE // NC - NON-COMBUSTIBLE // C - COMBUSTIBLE // NR - NOT REQUIRED

REFLECTIVE RED PANTONE (PMS) #187	S' DOUTE	ROMAN ALPHANUMERIC DESIGNATION OF CONSTRUCTION TYPE BASED ON SECTION 602 OF THE BUILDING CODE OF NEW YORK STATE
STRUCT COMPO OF TRU	NENTS THAT ARE	"F" FLOOR FRAMING, INCLUDING GIRDERS AND BEAMS "R" ROOF FRAMING "FR" FLOOR AND ROOF FRAMING

			N CODE REQUIREMENTS, R-VALUE METHOD
		TABLE C402.1.3	
LABEL	DESCRIPTION	VALUE	COMMENTS
1	CLIMATE ZONE	5A	
2	ATTIC AND OTHER	R-38	
3	WALLS ABOVE GRADE-WOOD FRAMED AND OTHER	R-13 + R-3.8CI OR, R-20	
4	WALLS BELOW GRADE	R-7.5Cl	
5	FLOORS-JOIST FRAMING	R-30	
6	SLAB ON GRADE — UNHEATED SLAB	R-10 FOR 24" BELOW	

(PRESCRIPTIVE VALUES HAVE BEEN USED TO MEET THE 2015 IECC REQUIREMENTS) ONLY THE BATHROOM AREA IS TO BE CONDITIONED

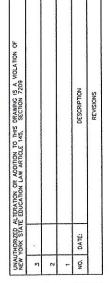



ANDREW SCHMIEDER, PE
11142 ALEXANDER ROAD, ATTICA, NY
(585) 297-3552

CODE COMPLIANCE	WANTE: STORAGE / RETAIL BUILDING	111 CEDAR ST., BATAVIA, NY	CEDAR STREET SALES	151 CEDAR STREET, BATAVIA, NY
000	PROJECT NAME: STORAGI	TH.	CED/	151 C

PROJECT NO.: 005-2019	PROJ. MGR.
DATE: 4-3-19	DRWN. BY:
SCALE: AS NOTED	CHKD. BY: ADS
DRAWING NO: N-1	
SHEET NO.	1 16

GENERAL NOTES

- STRUCTURE IS TO BE 60FT X 100FT POLE BARN TYPE CONSTRUCTION. BUILDING IS TO BE USED PRIMARILY FOR MATERIAL STORAGE. WITH PERIODIC RETAIL SALES. BUILDING WILL HAVE CONDITION BATHROOM.
- 2. DESIGN, CONSTRUCTION AND SAFETY SHALL CONFORM TO ALL LOCAL, STATE AND OWNER SPECIFIC CODES, INCLUDING (BUT NOT LIMITED TO) THE "NEW YORK STATE UNIFORM FIRE PROTECTION AND BUILDING CODE", LATEST REVISION, THE NFPA 101 LIFE SAFETY CODE, LATEST REVISION, ANSI A117.1 - LATEST REVISION, OSHA, AND ANY OTHER CODES GOVERNED BY THE JURISDICTION IN WHICH THIS PROJECT IS BEING CONSTRUCTED.
- 3. THIS CONTRACT REQUIRES COMPLETE, FINISHED WORKABLE PROJECT OF THE AREAS INDICATED BY THE CONTRACT DOCUMENTS, AND SHALL INCLUDE ALL MATERIALS AND LABOR NECESSARY TO COMPLETE, REGARDLESS OF WHETHER OR NOT ALL WORK OR EACH ITEM IS SPECIFICALLY INDICATED ON ANY OTHER PORTION OF THE DRAWINGS AND/OR NOTES.
- CONTRACTOR SHALL OBTAIN FROM OWNER ALL REQUIREMENTS FOR INSTALLATION OF OWNER PROVIDED EQUIPMENT INCLUDING ROUGHING DIAGRAMS, INSTALLATION INSTRUCTIONS, ELECTRICAL SCHEMATICS, TEMPLATES, LAYOUTS AND DIMENSIONS AND ALL OTHER INFORMATION NECESSARY FOR A PROPER, WELL COORDINATED INSTALLATION. PRIOR TO ROUGH-IN OF SERVICES, CONFER WITH OWNER EXACT LOCATION OF ALL ITEMS.
- 4. WOOD USED FOR BLOCKING OR OTHER PURPOSES ON OR ABOVE THE ROOF DECK, WITHIN 2'-0" OF GRADE AND OTHER LOCATIONS OUTSIDE THE BUILDING ENVELOPE WHERE EXPOSED TO THE WEATHER, SHALL BE PRESSURE TREATED
- 5. FINISHED DOOR OPENINGS SHALL BE NOMINAL 6" FROM FINISHED CORNER OF ROOM AT HINGE SIDE, EXCEPT WHERE DIMENSIONED OTHERWISE. ON THE 'PULL' SIDE OF A DOOR OPENING, THE STRIKE SIDE SHALL BE NOMINAL 18" FROM A PERPENDICULAR WALL. ON THE 'PUSH' SIDE OF A DOOR OPENING EQUIPPED WITH BOTH A CLOSER AND LATCH. THE STRIKE SIDE SHALL BE NOMINAL 12" FROM A PERPENDICULAR WALL.
- 6. REFER TO ELECTRICAL DRAWINGS FOR NOTES RELATED TO ELECTRICAL WORK.

CONCRETE/FOUNDATION NOTES

- 1. ALL FOOTINGS SHALL BE PLACED ON CLEAN, DRY, LEVEL, UNDISTURBED SOIL. DO NOT PLACE FOUNDATIONS ON FILL MATERIAL UNLESS ORDERED OTHERWISE BY THE ENGINEER.
- CONTROLLED COMPACTED FILL SHALL BE IMPORTED GRANULAR MATERIAL, SIMILAR IN GRADATION TO NYS DOT ITEM 304.02 OR 304.03. FILL SHALL BE SPREAD IN 8" THICK LAYERS AND UNIFORMLY COMPACTED WITH A MIN 4,000 Ib ROLLER.
- THE CONTRACTOR SHALL TAKE ALL NECESSARY MEASURES TO ENSURE EXCAVATIONS ARE DRY PRIOR TO PLACING CONCRETE.
- THE CONTRACTOR SHALL NOTIFY ARCHITECT BEFORE THE REMOVAL AND REPLACEMENT OF ANY UNSUITABLE OR UNSTABLE SUB GRADE SOILS ENCOUNTERED DURING
- 5. FOUNDATIONS HAVE BEEN DESIGNED FOR AN ALLOWABLE SOIL BEARING PRESSURE OF 2,500 PSF. CONTRACTOR TO NOTIFY PROJECT ENGINEER FOR VERIFICATION OF SOIL CONDITIONS PRIOR TO PLACING FOUNDATIONS.
- 6. 28 DAY COMPRESSIVE STRENGTH FOR ALL FOUNDATION CONCRETE SHALL BE 4000 PSI.
- 7. ALL REINFORCING BARS SHALL CONFORM TO ASTM A615
- PROVIDE CONCRETE COVER OVER REINFORCING IN ACCORDANCE WITH THE REQUIREMENTS OF A.C.I.
- ALL REINFORCING SHALL BE DETAILED, FABRICATED, AND PLACED IN ACCORDANCE WITH THE REQUIREMENTS OF
- 10. ALL SLABS-ON-GRADE SHALL BE PLACED OVER A 6" LAYER OF CLEAN, WELL-GRADED TYPE 1 & 2 CRUSHED STONE (CRUSHER RUN).
- 11. CONTROL JOINTS SHOWN ON DRAWINGS, SHALL BE CUT AS SOON AS SLAB HAS HARDENED SUFFICIENTLY TO SUPPORT MEN AND EQUIPMENT (USUALLY WITHIN 4 TO 12 HOURS).
- 12. ALL WELDED WIRE FABRIC (W.W.F.) SHALL CONFORM TO ASTM A185, WITH AN ULTIMATE TENSILE STRENGTH OF 70,000 PSI AND SHALL BE PROVIDED IN SHEETS.
- 13. MESH REINFORCING IN ALL SLABS-ON-GRADE SHALL BE PLACED IN THE UPPER THIRD OF THE SLAB.

		DOOR	SCHEDU	JLE			
LABEL	DESCRIPTION	GLASS	HARDWARE PACKAGE	SIZE	FIRE RATING	TYPE	COMMENTS
0-1)	INSULATED STEEL WITH HALF GLASS	28"x36"±	1	3'-0"x6'-8"	-	A	
(D-2)	ROLL-UP OVERHEAD DOOR		2	10'-0"x14'-0"			
0-3	ROLL-UP OVERHEAD DOOR		2	14'-0"x14'-0"			INSULATED
0-4	SOLID CORE WOOD		3	3'-0"x6'-8"	_	В	1" UNDERCUT

- ALL INTERIOR FRAMES TO BE WOOD FRAME
- 2. ALL GLASS IN DOORS SHALL BE CLEAR LAMINATED SAFTY GLASS.
- EXTERIOR DOORS SHALL BE THERMA TRU CONSTRUCTION SERIES STEEL DOOR SYSTEM W/ 1/4 FRAME & MOULDING GASKETED WITH " INSULATED, CLEAR LAMINATED SAFETY GLASS.

- ENTRY LOCKSET W/ CLOSER, WEATHER PACKAGE.
- PROVIDE MOTOR OPERATORS SUITABLE FOR DOOR SIZES

CARPENTRY NOTES


- 1. PROVIDE ALL ROUGH FRAMING AND SHEATHING AS SHOWN INCLUDING ANCHORS. SURFACE LUMBER 4
 SIDES TO COMPLY WITH SR-16 RECOMMENDATIONS, KILN DRIED TO A MOISTURE CONTENT NOT TO EXCEED 15%.
- 2. LAYOUT, CUT, FIT AND ERECT FRAMING FOR ROUGH CARPENTRY WORK. BRACE, PLUMB AND LEVEL ALL MEMBERS, AND IN TRUE ALIGNMENT, RIGIDLY SECURE IN PLACE WITH SUFFICIENT FASTENERS.
- 3. WOOD TRUSSES SHALL BE DESIGNED TO MEET NYS BUILDING CODE AND SHALL BE MANUFACTURED BY A RECOGNIZED SUPPLIER. SUPPLIER SHALL PROVIDE NYS PE STAMPED WORK DRAWINGS PRIOR TO FABRICATION. INSTALLATION OF THE WOOD TRUSSES SHALL BE IN STRICT COMPLIANCE WITH THE RECOMMENDATIONS OF THE TRUSS SUPPLIER INCLUDING, BUT NOT LIMITED TO BRACING, BRIDGING, AND SEQUENCING.
- 4. MINIMUM STRUCTURAL & FRAMING LUMBER SHALL HAVE A MINIMUM FB=1000 PSI, FV=95 PSI, Ft=450 PSI, Fc=1150 PSI & E=1,300,000.
- 5. ALL LUMBER IN CONTACT WITH GRADE SHALL BE PRESSURE TREATED. WOOD PRESERVATIVE SHALL MEET THE MINIMUM RETENTION AS SET FORTH IN THE LATEST AMERICAN WOOD-PRESERVERS ASSOCIATION COMMODITY
- 6. TIMBER POST TO BE PRESSURE TREATED TO A MINIMUM OF 6FT ABOVE FINISHED GRADE

SITE UTILITY NOTES

1. WATER, SEWER AND ELECTRICAL SERVICES WILL BE PROVIDED TO NEW

GENERAL NOTES:

1. ALL SPECIFIED ITEMS TO BE FURNISHED AS NOTED OR APPROVED EQUAL.

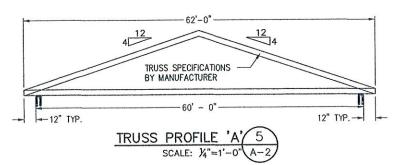

ROOF TRUSS DESIGN LOADS:

T.C.L.L.: BALANCED SNOW = 43 PSF UNBALANCED SNOW = 65 PSF

T.C.D.L. = 10 PSF

B.C.D.L. = 10 PSFT.C.L.L. = 40 PSF

B.C.L.L. = 0 PSF

GENERAL DESIGN LOAD NOTES

1. THE FOLLOWING CODES AND STANDARDS, INCLUDING ALL SPECIFICATION REFERENCED WITHIN, SHALL APPLY TO THE DESIGN, CONSTRUCTION, QUALITY CONTROL AND SAFETY OF ALL WORK PERFORMED ON THE PROJECT.

> A. "2016 IBC AS ADOPTED BY NEW YORK STATE". DEPARTMENT OF STATE, NEW YORK.

B. "MINIMUM DESIGN LOADS FOR BUILDING AND OTHER STRUCTURES", ANSI/ASCE AMERICAN SOCIETY OF CIVIL ENGINEERS.

2. ADDITIONAL CODES FOR MATERIALS SHALL BE FOUND IN THE APPROPRIATE SECTIONS THAT FOLLOW. SEE THOSE SECTIONS FOR THE APPLICABLE CODES.


EW	UNAUTHORIZED ALTERATION OR ADDITION TO THIS DRAWING IS A VIOLATION OF NEW YORK STATE EDUCATION LAW ARTICLE 145, SECTION 7209	
12		
2		
-		
Ö.	NO. DATE: DESCRIPTION	
	REVISIONS	



È SCHMIEDER ROAD, NDREW 11142

nne: GENERAL NOTES	STORAGE / RETAIL BUILDING 111 CEDAR ST., BATANA, NY	CEDAR STREET SALES 151 CEDAR STREET, BATAVIA, NY
DRAWING TITLE:	PROJECT NAME: ST(CLENT:

PROJECT NO.:	PROJ. MGR.
005-2019	ADS
DATE: 4-3-19	DRWN, BY:
SCALE:	CHKD. BY:
AS NOTED	ADS
N-2	
SHEET NO.	
3 °	116

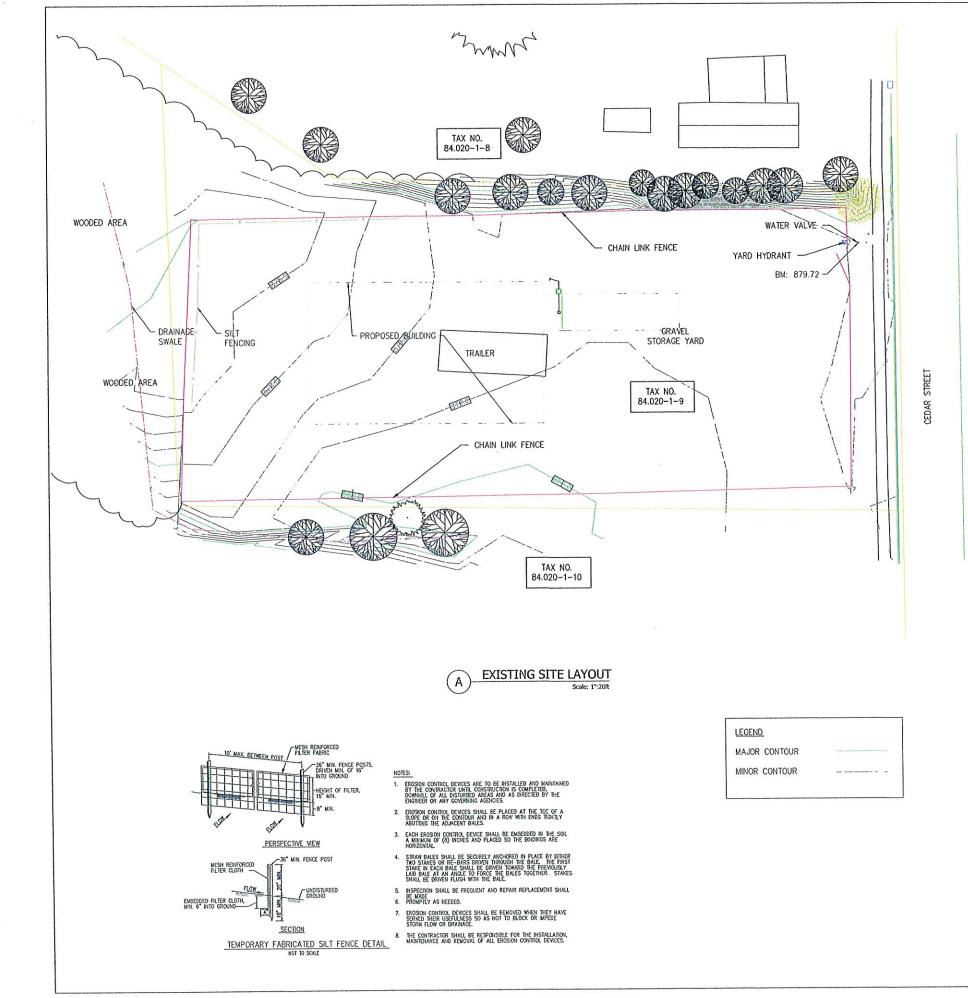

	SITE DAT	Α	
PARCEL AREA:	0.98 AC	RES	
TAX MAP. NO.	84.020-	1-9	
ZONING DISTRICT:	1-2 (11	NDUSTRIAL)	
PROPOSED USE: RE	TAIL STORA	GE	
ZONING REQUIREMEN	NTS	REQUIRED	PROPOSED
LOT AREA		40,000 sf	41,440 sf
BUILDING HEIGHT:		40 ft	28 ft
MAXIMUM BUILDING	COVERAGE	20%	18%
MINIMUM FRONT	AGE	150 ft	135 ft
MINIMUM FRONT	YARD	50 ft	140 ft
MINIMUM SIDE Y	ARD	15 ft	35 ft
MINIMUM REAR	/ARD	35 ft	55 ft

EROSION CONTROL NOTE

THE EQUIPMENT ANTICIPATED TO BE USED FOR THE CONSTRUCTION INCLUDES THE FOLLOWING: BACKHOES, BULLDOZERS, LOADERS, TRUCKS, CRANES, COMPACTORS, AND GRADERS. THE FOLLOWING MEASURES SHALL BE UNDERTAKEN TO PROVIDE MAXIMUM PROTECTION TO THE SOIL, WATER, AND ABIUTTING LANDS:

- 1. PRIOR TO GRUBBING OR ANY EARTH MOVING OPERATION, SILTATION FENCE OR EROSION CONTROL BERMS SHALL BE INSTALLED ACROSS THE SLOPE ON THE CONTOUR AT THE DOWNHILL LIMIT OF THE WORK AS PROTECTION AGAINST CONSTRUCTION RELATED EROSION. REFERE TO DETAILS SHOWN ON EROSION CONTROL PLAN.
- 2. PERMANENT SOIL EROSION CONTROL MEASURES FOR ALL SLOPES, CHANNELS, DITCHES, OR ANY DISTURBED LAND AREA SHALL BE COMPLETED WITHIN FIFTEEN CALENDAR DAYS AFTER FINAL GRADING HAS BEEN COMPLETED. WHEN IT IS NOT POSSIBLE OR PRACTICAL TO PERMANENTLY STABILIZE DISTURBED LAND, TEMPORARY EROSION CONTROL MEASURES SHALL BE IMPLEMENTED WITHIN THIRTY CALENDAR DAYS OF EXPOSURE OF SOIL. ALL DISTURBED AREAS SHALL BE MULCHED FOR EROSION CONTROL UPON COMPLETION OF ROUGH GRADING.
- 3. ANY EXPOSED SLOPES GREATER THAN 3:1 AND NEWLY CONSTRUCTED DRAINAGE SWALES SHALL BE STABILIZED WITH EROSION CONTROL MESH TO PREVENT EROSION DURING CONSTRUCTION AND TO FACILITATE RE-VEGETATION AFTER TOP SOILING AND SEEDING.
- 4. IN AREAS OF CONSTRUCTION DEWATERING, PUMPED DISCHARGE SEDIMENT DEVICES SHALL BE UTILIZED ADJACENT TO THE ACTIVITY. SEDIMENT TRAPS SHALL BE CONSTRUCTED UTILIZING DIRTBAGS, OR OTHER SIMILAR DEVICES THAT DO NOT REQUIRE ADDITIONAL SOIL DISTURBANCE. ADDITIONAL SEDIMENTATION PROTECTION SHALL BE PROVIDED BY THE INSTALLATION OF HAY BALE BARRIERS BETWEEN THE SEDIMENT TRAPS AND THE RECEIVING DRAINAGE COURSE.
- 5. NATIVE TOPSOIL SHALL BE SAVED, STOCKPILED, MULCHED, AND REUSED AS MUCH AS POSSIBLE ON THE SITE. SILTATION FENCE SHALL BE INSTALLED AT THE BASE OF STOCKPILES AT THE DOWNHILL LIMIT TO PROTECT AGAINST EROSION. STOCKPILES SHALL BE STABILIZED BY SEEDING AND MULCHING UPON FORMATION OF THE PILES. UPHILL OF THE STOCKPILES, STABILIZED DITCHES AND/OR BERMS SHALL BE CONSTRUCTED TO DIVERT STORMWATER RUNOFF AWAY FROM THE PILES.
- 6. ALL SILTATION FENCE AND HAY BALE BARRIERS SHALL BE INSPECTED BY THE CONTRACTOR ON A WEEKLY BASIS OR FOLLOWING ANY SIGNIFICANT RAINFALL (1/2INCH OR MORE) OR SNOWMELT. ALL DAMAGED EROSION CONTROL DEVICES SHALL BE REPAIRED AND/OR REPLACED IMMEDIATELY. TRAPPED SEDIMENT SHALL BE REMOVED BEFORE IT HAS ACCUMULATED TO ONEHALF OF THE INSTALLED SILTATION FENCE OR HAY BALE BARRIER HEIGHT. DEVICES NO LONGER SERVICEABLE DUE TO SEDIMENT ACCUMULATION SHALL ALSO BE REPAIRED AND/OR REPLACED AS NECESSARY.
- 7. IF FINAL SEEDING OF THE DISTURBED AREAS IS NOT COMPLETED BY SEPTEMBER 15 OF THE YEAR OF CONSTRUCTION, THEN WITHIN THE NEXT 10 CALENDAR DAYS THESE AREAS SHALL BE GRADED AND SMOOTHED, THEN SEEDED TO A WINTER COVER CROP OF RYE AT A RATE OF 3 LBS. PER 1,000 SQ. FT. THE FOLLWING SHALL BE INCORPORATED INTO THE SOIL PRIOR TO RYE SEEDING: GROUND LIMESTONE AT A RATE OF 130 LBS. PER 1,000 SQ. FT., FOLLOWED BY A 10-10-10 FERTILIZER AT A RATE OF 14 LBS. PER 1,000 SQ. FT. HAY MULCH SHALL BE APPLIED AT A RATE OF 10 LBS. PER 1,000 SQ. FT. FOLLOWING SEEDING. IF THE RYE SEEDING CANNOT BE COMPLETED BY OCTOBER 1, THEN ON THAT DAY HAY MULCH SHALL BE APPLIED AT THE RATE OF 2 TONS PER ACRE TO PROVIDE WINTER PROTECTION. IF RYE DOES NOT MAKE ADEQUATE GROWTH BY NOVEMBER 5, THEN ON THAT DATE, HAY MULCH SHALL BE APPLIED AT THE RATE OF 100 SQ. FT. A SUITABLE BINDER SUCH AS CURASOL OR RMB PLUS SHALL BE USED ON HAY MULCH FOR WIND CONTROL. BIODEGRADABLE NETTING SHALL BE INSTALLED ON STEEP SLOPSE (3:1 AND STEEPER) AND ON AREAS OF CONCENTRATED FLOWS.
- 8. INTERCEPTED SEDIMENT SHALL BE RETURNED TO THE SITE AND INCORPORATED INTO THE PROJECT AREA.
- 9. SHOULD CONSTRUCTION OCCUR AFTER NOVEMBER 15, ADDITIONAL EROSION CONTROL METHODS SHALL BE IMPLEMENTED. ALL DISTURBED AREAS SHALL BE MINIMIZED AS MUCH AS POSSIBLE. PRIOR TO FREEZING, ADDITIONAL EROSION CONTROL DEVICES SHALL BE INSTALLED AS APPROPRIATE. INSPECTION OF THESE EROSION CONTROL ITEMS SHALL BE CONSTANT, WITH PARTICULAR ATTENTION PAID TO WEATHER PREDICTIONS TO ENSURE THAT THESE MEASURES ARE PROPERLY IN PLACE TO HANDLE LARGE AMOUNTS OF RUNOFF FROM HEAVY RAINS OR THAWS.
- 10. FOR EARTHWORK PERFORMED BY TOWN PERSONNEL, EROSION CONTROL MEASURES INSTALLATION AND MAINTENANCE WILL BE RESPONSIBILITY OF TOWN. EROSION CONTROL MEASURES REQUIRED DUE TO CONTRACTORS WORK WILL BE INSTALLED AND MAINTAINED BY THEM.


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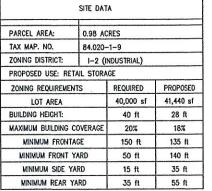


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EXISTING SITE LAYOUT
PROJECT NAME.
STORAGE / RETAIL BUILDING
111 CEDAR STREET SALES
151 CEDAR STREET SALES
151 CEDAR STREET, BATANA, NY

C-1	
SCALE: AS NOTED DRAWING NO:	CHKD. BY: ADS
DATE: 4-15-19	DRWN, BY:
PROJECT NO.: 005-2019	PROJ. MGR. ADS



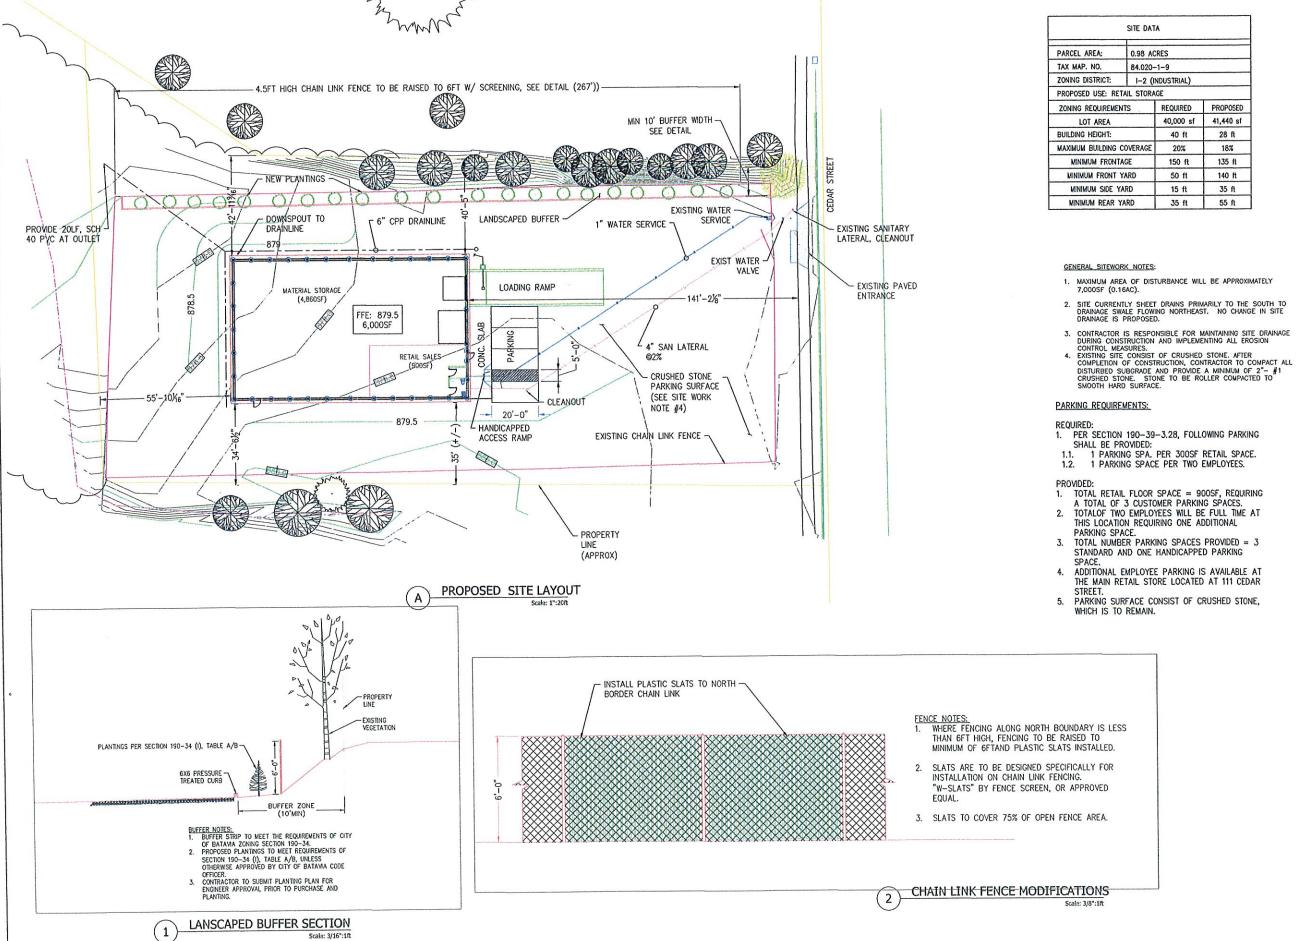

- MAXIMUM AREA OF DISTURBANCE WILL BE APPROXIMATELY 7,000SF (0.16AC).
- SITE CURRENTLY SHEET DRAINS PRIMARILY TO THE SOUTH TO DRAINAGE SWALE FLOWING NORTHEAST. NO CHANGE IN SITE DRAINAGE IS PROPOSED.

- PER SECTION 190-39-3.28, FOLLOWING PARKING SHALL BE PROVIDED:
- 1.2. 1 PARKING SPACE PER TWO EMPLOYEES.
- TOTAL RETAIL FLOOR SPACE = 900SF, REQUIRING A TOTAL OF 3 CUSTOMER PARKING SPACES.
- TOTALOF TWO EMPLOYEES WILL BE FULL TIME AT THIS LOCATION REQUIRING ONE ADDITIONAL
- TOTAL NUMBER PARKING SPACES PROVIDED = 3 STANDARD AND ONE HANDICAPPED PARKING
- 4. ADDITIONAL EMPLOYEE PARKING IS AVAILABLE AT THE MAIN RETAIL STORE LOCATED AT 111 CEDAR
- 5. PARKING SURFACE CONSIST OF CRUSHED STONE,







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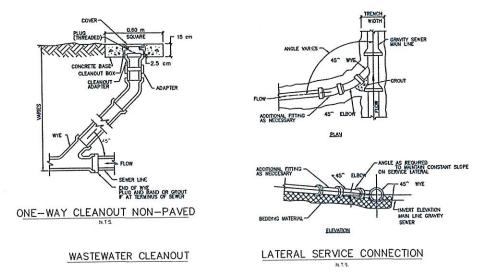
STORAGE / RETAIL BUILDING
111 CEDAR ST., BATAVIA, NY LAYOUT SITE PROPOSED


PROJECT NO.: 005-2019	PROJ. MGR.
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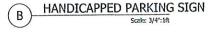



CONCRETE PAVEMENT

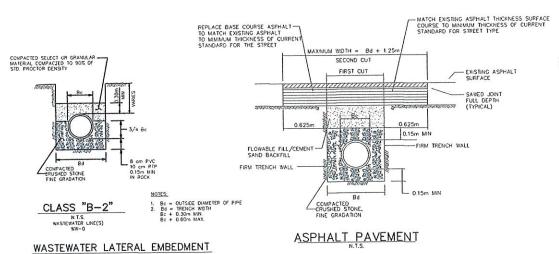

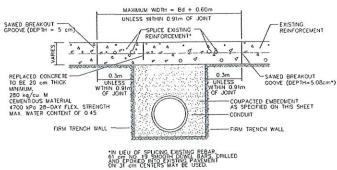

 Handicap sign(s) may be affixed on permanent structures in lieu of installing on poles.

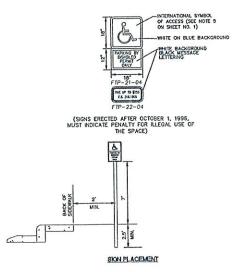

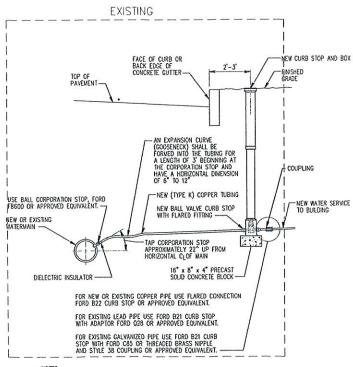


NOTES:

THE SERVICE IS TO HAVE A MINIMUM COVER DEPTH OF 4 FEET 6 INCHES.

- 2. USE A BRASS TAPPING SADDLE WHERE REQUIRED.
- 3. THE SERVICE TAP IS TO BE MADE ON SIDE OF MAIN FACING CUSTOMER.
- 4. THE SERVICE IS TO RUN PERPENDICULAR TO THE MAIN.
- 5. ADD A CURB BOX ARCH BASE TO CURB BOX FOR SERVICES LARGER THAN 1 1/2 INCH.
- FORD, MUELLER AND MCDONALD ARE APPROVED MANUFACTURERS FOR CORPORATION STOPS, CURB STOPS AND COUPLINGS. SEE CURRENT APPROVED PRODUCT LIST AS SUPPLIED BY WATER BUREAU.

NEW WATER SERVICE 3/4" TO 2"

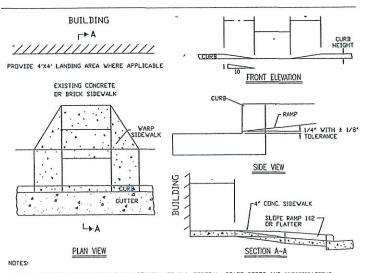

I. HANDICAP RAMP CONSTRUCTION SHALL CONFORM TO ALL FEDERAL, STATE CODES AND SPECIFICATIONS.
2. SURFACES SHALL MEET THE GUIDELINES OF THE ADA STANDARDS FOR ACCESSIBILITY, APPENDIX A, PART 36.
3. WHERE SIDEWALK IS FLUSH WITH BACK OF CURB, DELETE ADDITIONAL 4' CONCRETE SIDEWALK AND TRANSITION THE CURB AND SIDEWALK SUCH THAT THE MAXIMUM SLOPE OF THE RAMP AND TRANSITION SIDEWALK IS 142.

4. THE FLARED SIDES MUST HAVE A 110 SLOPE. IF THE DISTANCE χ IS LESS THAN 48°, THEN THE SLOPE OF THE FLARED SIDES SHALL NOT EXCEED 142.







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CEDAR STREET SALES	CLIENT:	111 CEDAR ST., BATAVIA, NY	STORAGE / RETAIL BUILDING	PROJECT NAME:	פוור טבואונט	SITE DETAILS	DRAWING TITLE:	SITE DETAILS TRAME. STORAGE / RETAIL BUILDING 111 GEDAR ST., BATANA, NY CEDAR STREET SALES
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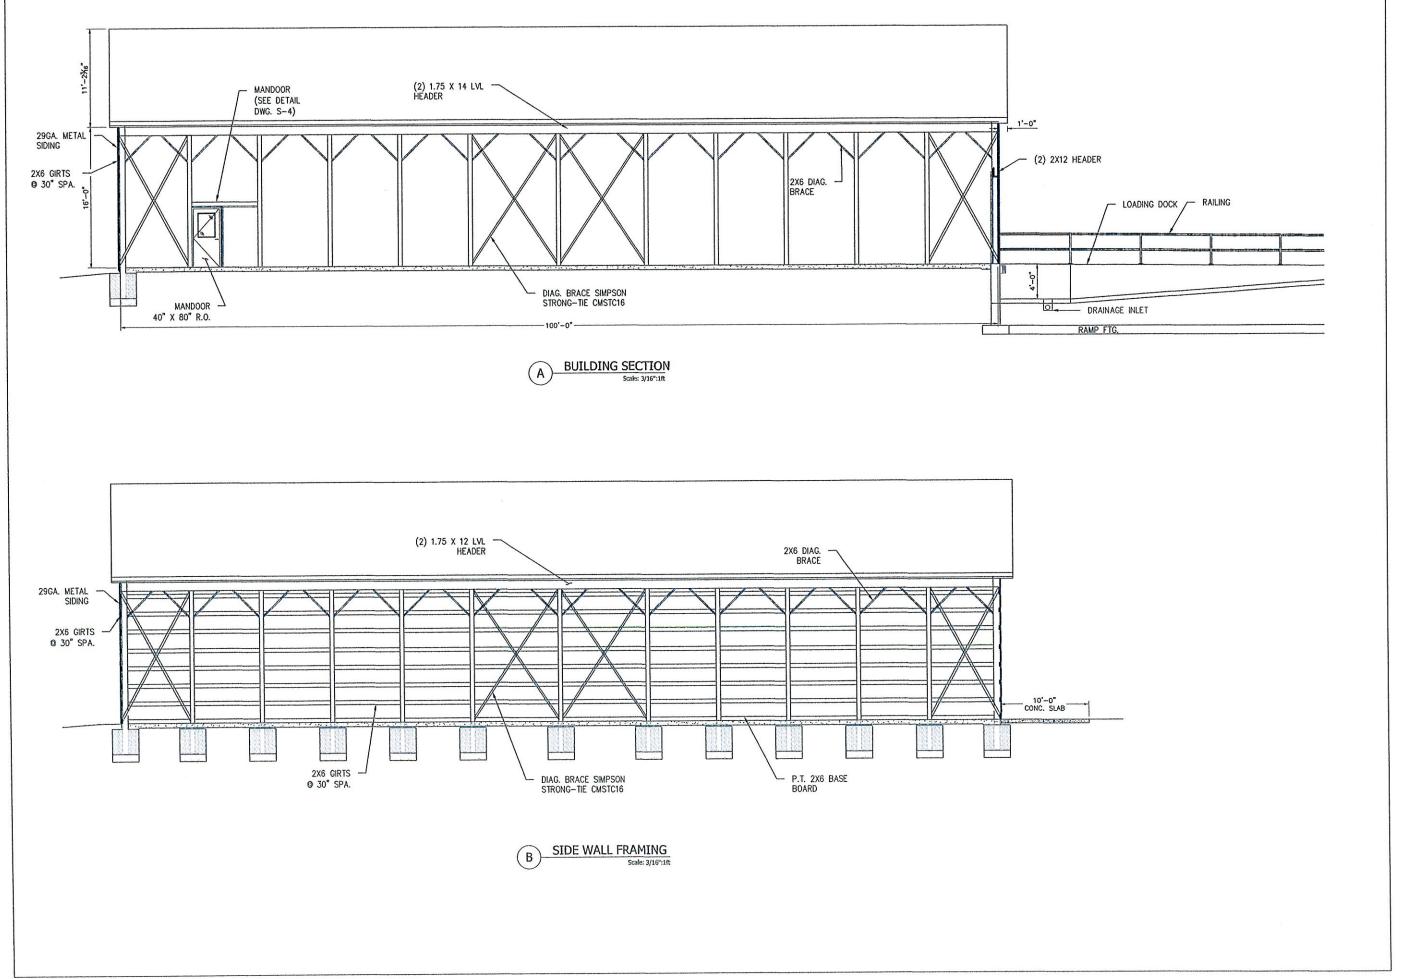




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BUILDING LAYOUT	STORAGE / RETAIL BUILDING 111 GEDAR ST., BATAWA, NY	CEDAR STREET SALES 151 CEDAR STREET, BATAWA, NY
ш	STOR	2
	PROJECT NAME: ST(CLENT:

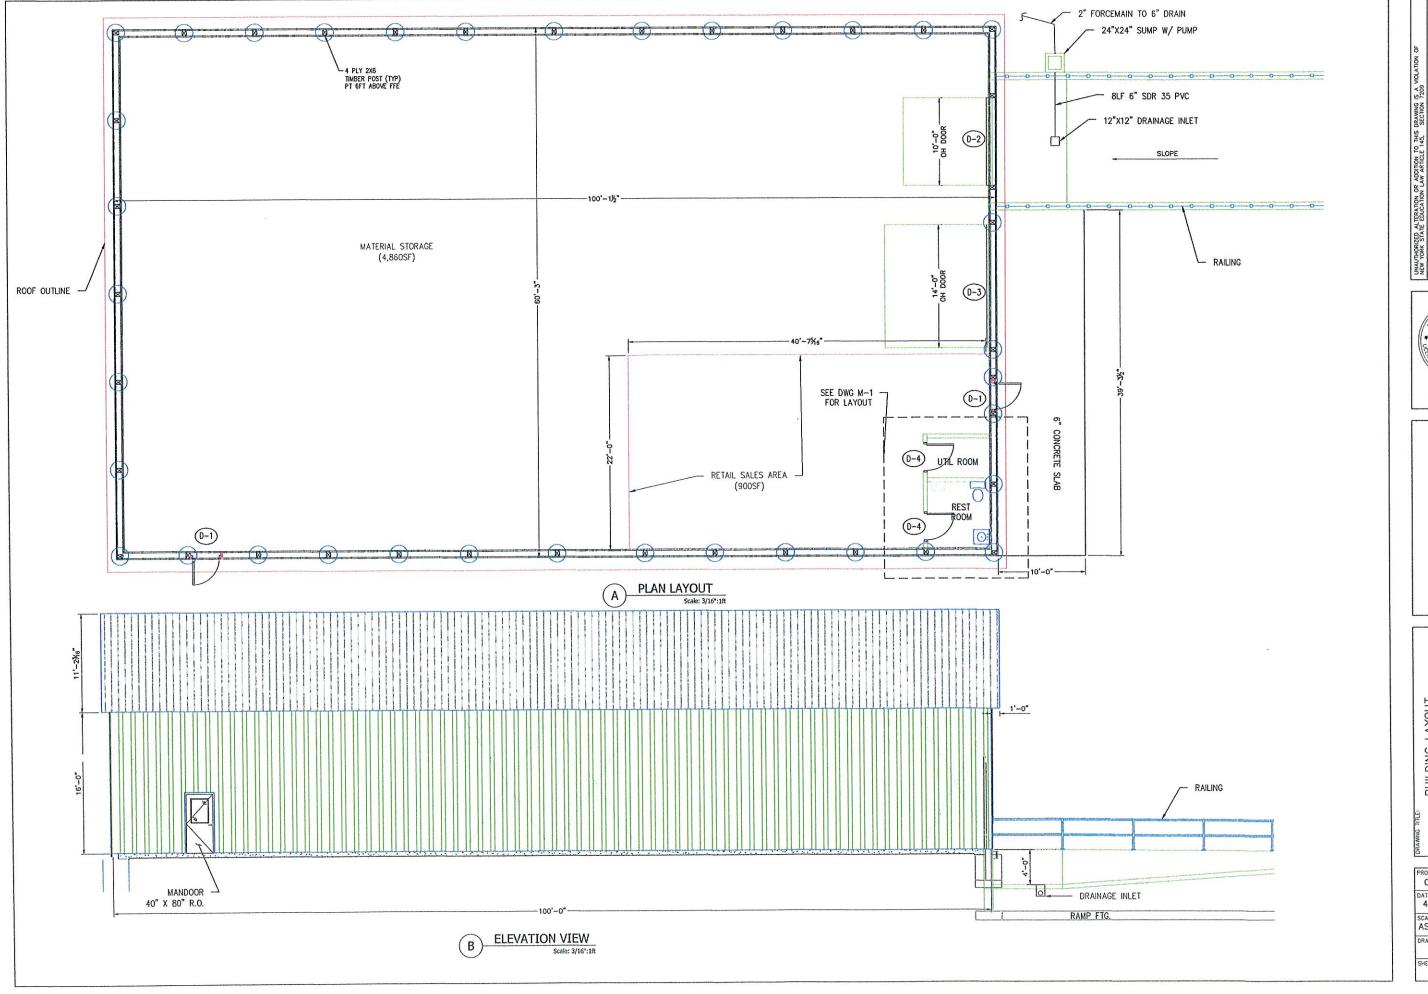PROJECT NO.: 005-2019	PROJ. MGR.
DATE: 4-3-19	DRWN. BY:
SCALE: AS NOTED	CHKD. BY: ADS
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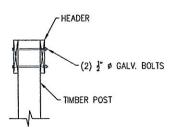
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4-3-19
SCALE:
AS NOTED
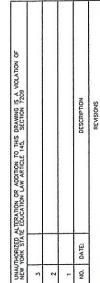
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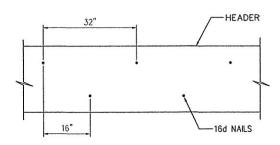
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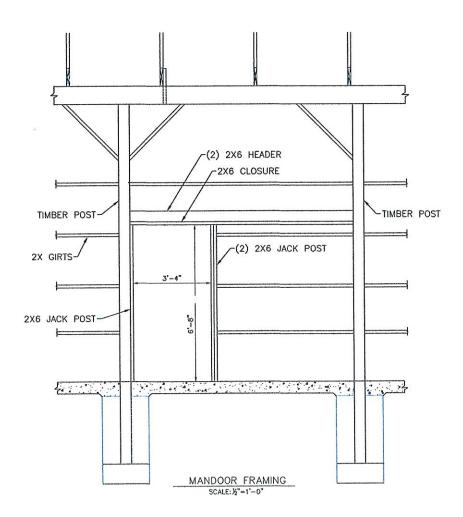



HEADER CONNECTION DETAIL

SCALE: ¾"=1'-0"




TYPICAL HEADER NAIL PATTERN SCALE: N.T.S.



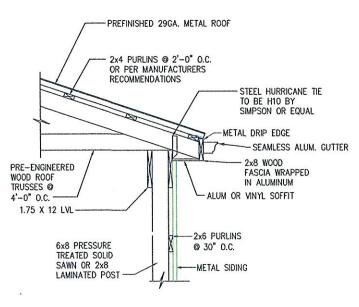

TYPICAL FASCIA DETAIL

SCALE: 3/4"=1'-0"

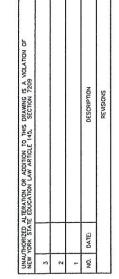



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STRUCTURAL DETAILS	PROJECT NAME: STORAGE / RETAIL BUILDING 111 CEDAR ST., BATANA, NY	CEDAR STREET SALES 151 CEDAR STREET, BATANA, NY
	PRO	CLIENT


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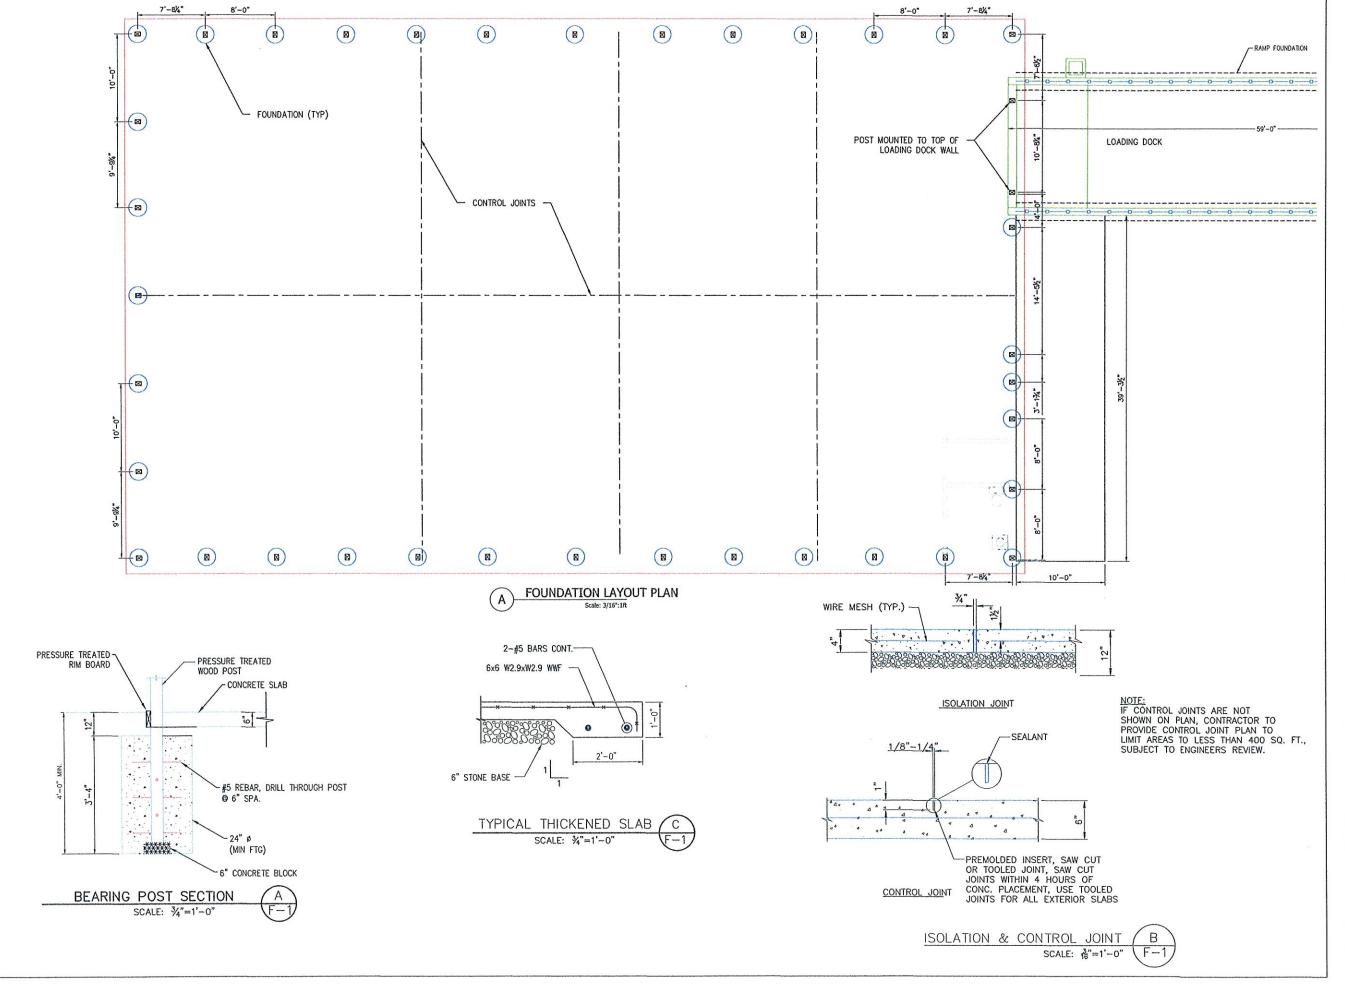





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	PROJECT NAME: STORAGE / RETAIL BUILDING 111 CEDAR ST., BATANA, NY	CEDAR STREET SALES
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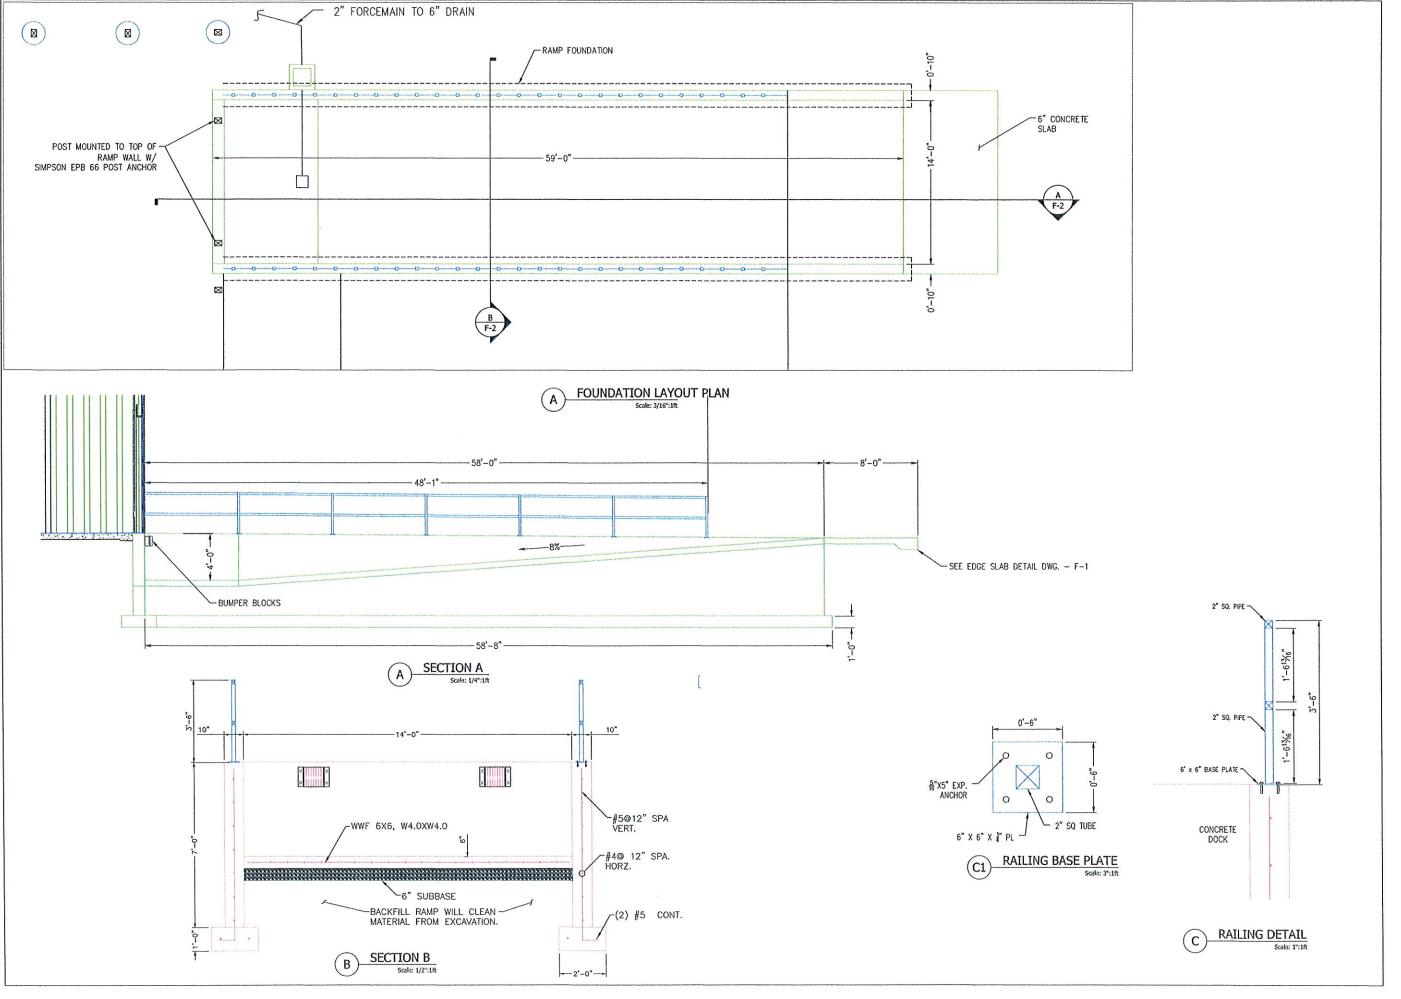




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DRAWING TITE:
FROJECT NAME:
STORAGE / RETAIL BUILDING
TH CEDAR ST., BATANA, NY
CLIENT:
CEDAR STREET SALES
15) CEDAR STREET SALES
15) CEDAR STREET SALANA, NY

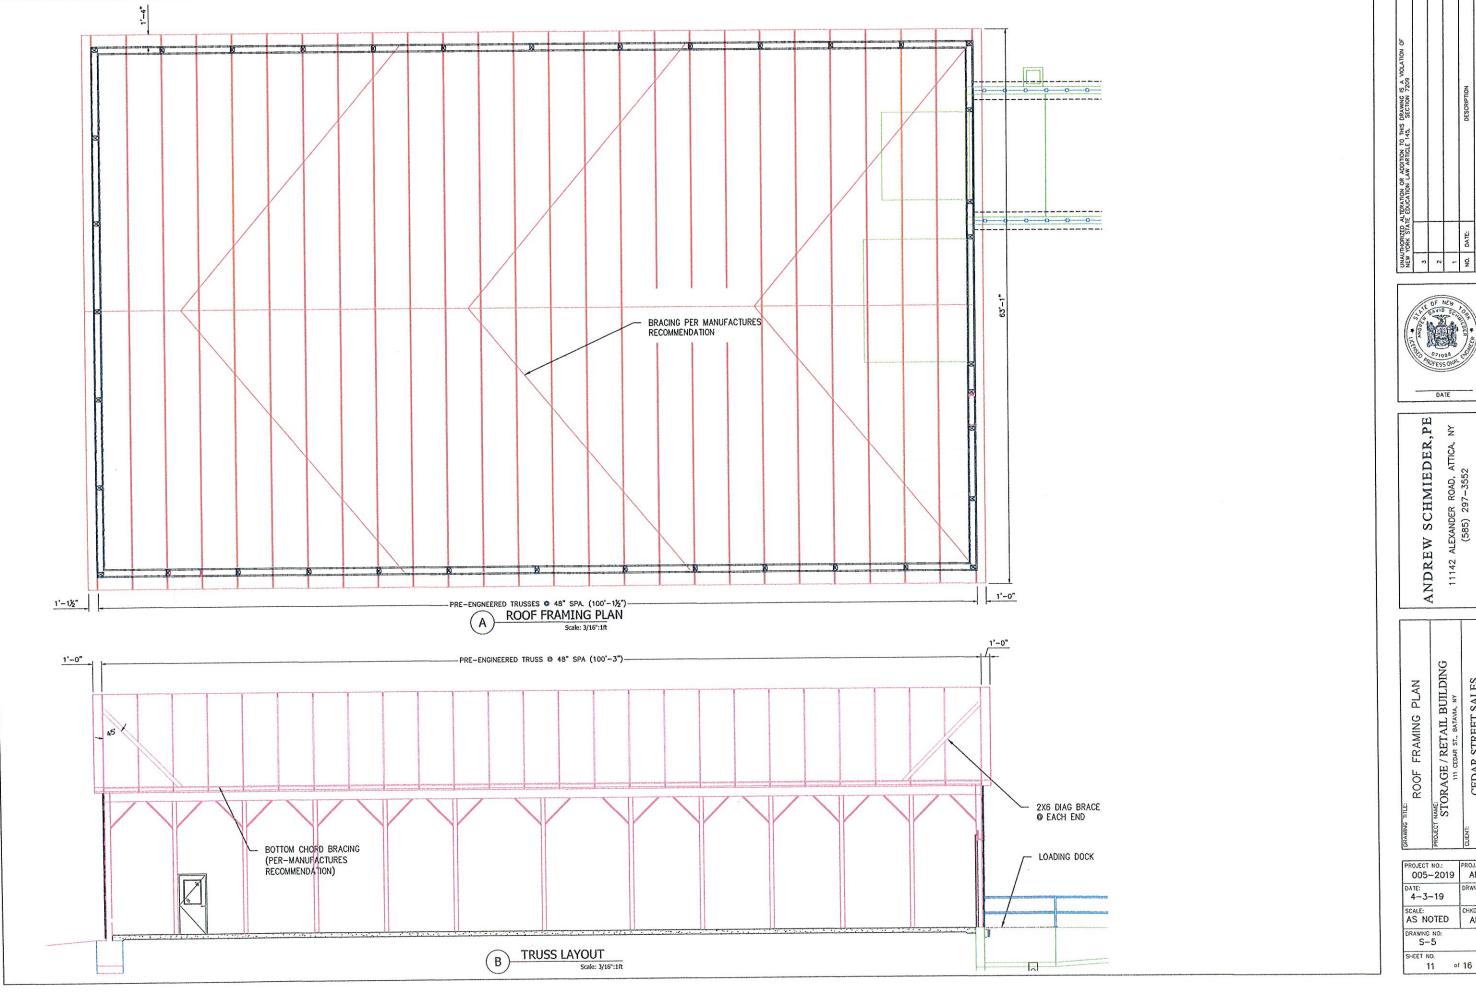PROJECT NO.:	PROJ. MGR
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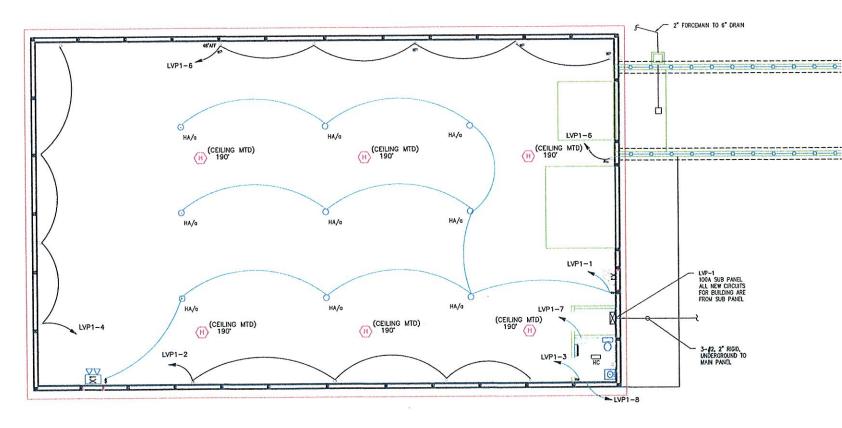


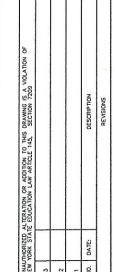



	DETAILS	BUILDING	MA, NY	CALEC	SALES	AVIA, NT
	LOADING DOCK DETAILS	PROJECT NAME: STORAGE / RETAIL BUILDING	111 CEDAR ST., BATAMA, NY	NE CEDAD STREET SAIES	CEDAR SINE	151 CEDAR STREET, BATAVIA, NT
5		PRO		CLIENT:		

DATE: 4-3-19	DRWN. BY:
SCALE: AS NOTED	CHKD. BY:
F-2	
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	ELECTRICAL	PLAN
A		Scale: 1/8":1f

	LUMINAIRE SCHEDULE							
TYPE	DESCRIPTION	LUMENS	LAMPS	VOLTAGE	ACCEPTABLE MANUFACTURER			
НА	BLIZZARD EXT— 100W LED HIGH BAY LUMINAIRE BY INDUSTRIAL LIGHTING SYSTEMS, UL LISTED FOR DAMP LOCATIONS.	12,166	LED	120	APPROVED EQUAL			
нс	RECESSED LIGHTING FIXTURE, LITHONIA 6BPMW LED, 6" DIA. 725 LUMENS	12.7	LED	120	APPROVED EQUAL			
EM/X1	TLC LED EMERGENCY LIGHT (TLC2-B-TCVS), BY EVENLITE	125	LED	120	HUBBEL/APPROVED EQUAL			

ELECTRICAL NOTES:

- INSTALL ALL WIRING AND EQUIPMENT IN ACCORDANCE WITH THE NFPA 70, NFPA 110 AND THE NFPA 111 2015 NATIONAL ELECTRICAL CODE.
- 2. OBTAIN AN UNDERWRITERS CERTIFICATE UPON SUBSTATIAL COMPLETION.
- 3. COORDINATE ALL WORK WITH OTHER TRADES.
- 4. WIRE SHALL BE STRANDED COPPER WITH THHN/THWN INSULATION, MINIMUM #12 AWG.
- 5. CONCEALED CONDUIT SHALL BE EMT WITH SET SCREW FITTINGS.
- EXPOSED CONDUIT SHALL BE RIGID STEEL WITH THREADED FITTINGS. TYPE MC CABLE WITH A SEPARATE INSULATED GROUND IS PERMITTED. SUPPORT CABLE ON MINIMUM 4.5' CENTERS.
- ALL HOMERUNS TO PANELBOARDS SHALL BE INSTALLED IN EMT CONDUIT. TYPE MC CABLE MAY BE USED FROM OUTLET BOXES IN THE CEILING TO DEVICES AND LUMINAIRES, AND MAY BE RUN HORIZONTALLY IN THE METAL STUD PARTITIONS.
- 8. WIRING DEVICES SHALL BE SPECIFICATION GRADE, THERMOPLASTIC COVERPLATES. MAKE SHALL BE HUBBELL OR EQUAL.
- WEATHER RESISTANT DEVICE COVERS SHALL BE UL LISTED WITH THE DEVICE PLUGGED IN. MAKE SHALL BE HUBBELL OR EQUAL.
- PANELBOARDS SHALL HAVE ALUMINUM BUS WITH PLUG-ON CIRCUIT BREAKERS AND SURFACE HINGED TRIM. MAKE SHALL BE SQUARE D OR EQUAL.
- 11. ELECTRIC SERVICE TO BE FROM EXISTING PANELBOARD LOCATED IN EXISTING SERVICE BUILDING BUILDING. ELECTRIC SERVICE TO BE PLACE BELOW GROUND IN PVC CONDUIT
- CONDUT AND CABLE SHALL BE RUN PARALLEL OR PERPENDICULAR TO BUILDING STRUCTURES AND SHALL BE SECURELY HUNG OR SUPPORTED FROM THE BUILDING STRUCTURE WITH MAXIMUM CLEARANCE ABOVE FINISHED FLOOR UNLESS OTHERWISE NOTED.
- ALL ELECTRICAL WORK IN FNISHED AREAS SHALL BE RUN CONCEALED WITH ALL RECEPTACLES, SMITCHES, DEVICES AND JUNCTION BOXES INSTALLED FLUSH.
- ALL MATERIALS AND WORK SHALL BE GUARANTEED FOR A MINIMUM OF ONE (1) YEAR FROM THE DATE OF FINAL ACCEPTANCE BY THE OWNER.
- 15. LIGHTING AND RECEPTACLES LOADS ARE NOT TO BE CONNECTED TO THE SAME CIRCUIT.
- CONNECT ALL CIRCUITS SO THAT THE LOAD ON ANY CIRCUIT DOES NOT EXCEED 80% OF THE RATING OF THE CIRCUIT PER THE NATIONAL ELECTRICAL CODE.
- HEAT DETECTORS TO BE CONNECTED TO FIRE ALARM CONTROL PANEL (FACP) IN MAIN BUILDING. CONTRACTOR TO PROVIDE SHOP DRAWING OF THE FIRE ALARM SYSTEM PRIOR TO PURCHASE AND INSTALLATION.
- 18. REFER TO DWG. E-2 FOR PANELBOARD SCHEDULE

	MISCELLANEOUS LEGEND	El	LECTRICAL LIGHTING LEGEND		
SYMBOL	DESCRIPTION	SYMBOL	DESCRIPTION		
1	REFERENCE TO DRAWING NOTE	\$	SINGLE POLE SWITCH		
2	REVISION NOTE	OFA	DOWNLIGHT. DESIGNATION REFERS TO LUMINAIRE SCHEDULE		
	ELECTRICAL POWER LEGEND	PC PC_	PHOTOCELL. NUMBER INDICATES		
SYMBOL	DESCRIPTION				
0	DUPLEX RECEPTACLE, SUBSCRIPTS AS FOLLOWS:	EM . EMERGENCY LIGHT			
Ħ	SUBSCRIPTS AS FOLLOWS: AFI ARC FAULT INTERRUPTER CR CORROSION RESISTANT	H	HEAT DETECTOR		
	EP EXPLOSION PROOF GFI GROUND FAULT INTERRUPTER	Р	OWER DISTRIBUTION LEGEND		
	WP WELDING PLUG IG ISOLATED GROUND	SYMBOL	DESCRIPTION		
	SS SURGE SUPPRESSION WEATHERPROOF		SURFACE MOUNTED BRANCH		
LP1-2	CIRCUITS PER NEC ARE		CIRCUIT PANELBOARD. 208Y/120V OR 240/120V. REFER TO PANEL BOARD SCHEDULE		
	ALLOWABLE.	-			
	INDICATES NEW DEVICE OR EQUIPMENT				





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ELECTRICAL PLAN

PROJECT NAME
STORAGE / RETAIL BUILDING
111 CEDAR ST., BATANA, NY
CLENT.

CEDAR STREET SALES
151 CEDAR STREET, BATANA, NY

005-2019

4-25-19


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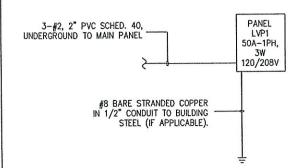
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E-1

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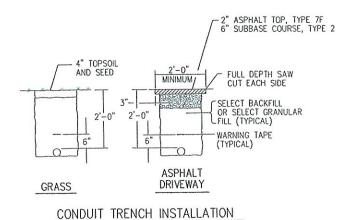
ADS

of 16





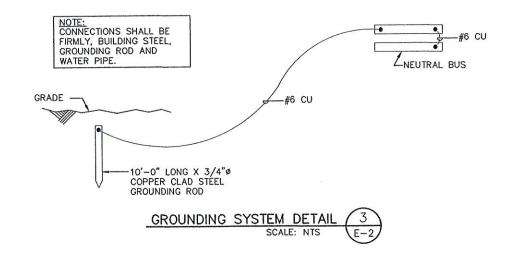



NOT TO SCALE

					PA	ANEL LVI	P1					
MAIN CIRCUIT BREAKER: 100A MG	CB			001000000000000000000000000000000000000				PROJ	ECT I	NAME:	(CEDAR STREET RETAILS
MAIN BUS: 100A								FED I	FROM			STREET
VOLTAGE: 208Y/120V 1PH -3W								LOCA	TION:			_
MAXIMUM AVAILABLE SHORT CKT. O	URREN	T:	22 KAIC				MOUNTING:			,	SURFACE	
						,						
LOCATION	LOAD W		BKR.		СКТ	BUS	СКТ	BK	R.	LOA	D W	LOCATION
ECCATION	ØA	ØB	P	Α	CKI	503	OK I	Α	P	ØA	ØB	
INTERIOR LIGHT	488		1	20	1	+	2	20	1	540		RECEPTACLE
INTERIOR LIGHT		150	1	20	3	-	4	20	1		360	RECEPTACLE
EXTERIOR LIGHT	-		1	20	5		6	20	1			RECEPTACLE
ELECTRIC WATER HEATER		-	1	20	7	1	8	20	1		-	ELECTRIC SPACE HEATER
SPARE	-		1	20	9		10	20	1	-		SPARE
SPARE		-	1	20	11	1	12	20	1		-	SPARE
PHASE LOAD	-	-								-	-	PHASE LOAD
MAX. PHASE CURRENT: ØA			TOT	AL CO	DNNEC.	TED LOAD	:	- KW				S: *PROVIDE GFCI BREAKER
	2B -	-									** PR	OVIDE LOCK-ON CIRCUIT BREAKER

ELECTRICAL NOTES:

ALL ELECTRICAL WORK SHALL BE IN STRICT ACCORDANCE WITH THE NATIONAL ELECTRICAL CODE-YEAR OF THE LATEST REVISION AND ALL OTHER APPLICABLE CODES, RULES AND REGULATIONS. ANY LABOR, MATERIALS AND EQUIPMENT NECESSARY DUE TO NON-CONFORMANCE WITH THE ABOVE SHALL BE FURNISHED BY THE CONTRACTOR AT NO ADDITIONAL COST TO THE OWNER.

ALL LIGHTING FIXTURES SHALL BE COMPLETELY LAMPED AND OPERABLE.

ALL EQUIPMENT SHALL BE U.L. LISTED AND LABELED.

THE CONTRACTOR SHALL BE RESPONSIBLE FOR ALL PERMITS FEES AND INSPECTIONS. BEFORE POWER IS APPLIED, THE CONTRACTOR SHALL OBTAIN APPROVAL OF ALL REGULATORY AGENCIES HAVING JURISDICTION AND SHALL FURNISH WRITTEN PROOF OF SAME TO OWNER.

ALL EQUIPMENT SHALL BE INSTALLED IN STRICT ACCORDANCE WITH THE MANUFACTURER'S RECOMMENDATIONS AND INSTRUCTIONS.

THE CONTRACTOR SHALL BE RESPONSIBLE FOR ALL CONTACTS AND COORDINATION WITH ELECTRIC COMPANY, ANY AND ALL FEES REQUIRED BY THE OF ELECTRIC COMPANY SHALL BE BORNE BY THE CONTRACTOR.

LOCATIONS OF EQUIPMENT SHOWN ON THE DRAWINGS SHALL BE CONSIDERED APPROXIMATE. THE CONTRACTOR SHALL VERIFY THE EXACT LOCATION WITH THE OWNER/ARCHITECT IN THE FIELD PRIOR TO INSTALLATION OF THE EQUIPMENT OR WIRING.

CONDUIT SHALL BE RIGID GALVANIZED STEEL (PVC COATED) WITH SEALED JOINTS WHERE INSTALLED UNDERGROUND OR UNDER THE SLAB, CONDUIT IN OTHER UNFINISHED AREAS MAY BE MET WHERE PERMITTED BY CODE.

CONDUIT AND CABLE SHALL BE RUN PARALLEL OR PERPENDICULAR TO BUILDING STRUCTURES AND SHALL BE SECURELY HUNG OR SUPPORTED FROM THE BUILDING STRUCTURE WITH MAXIMUM CLEARANCE ABOVE FINISHED FLOOR UNLESS OTHERWISE NOTED.

ALL ELECTRICAL WORK IN FINISHED AREAS SHALL BE RUN CONCEALED WITH ALL RECEPTACLES, SWITCHES, DEVICES AND JUNCTION BOXES INSTALLED FLUSH.

FURNISH AND INSTALL STEEL SLEEVES WITH RESILIENT SEAL FOR ALL FOUNDATION WALL AND FOOTING PENETRATIONS.

UNA	JTHORIZED ALTERATIO YORK STATE EDUCAT	IN OR ADDITION TO THIS RION LAW ARTICLE 145,	Unauthorized Alteration or addition to this drawing is a volation of New York State Education Law article 145, Section 7209	
m				
2				
-				
Ŏ.	DATE:		DESCRIPTION	
			REVISIONS	




ANDREW SCHMIEDER,PE
11142 ALEXANDER ROAD, ATTICA, NY
(585) 297-3552

ELECTRICAL DETAILS

DGECT NAME.
STORAGE / RETAIL BUILDING
111 CEDAR ST. BATAMA, NY
151 CEDAR STREET SALES
151 CEDAR STREET BATAMA, NY

PROJECT NO.: 005-2019	PROJ. MGR.
DATE: 4-17-19	DRWN. BY:
SCALE: AS NOTED	CHKD. BY: ADS
DRAWING NO: E-2	
SHEET NO.	
15	f 16

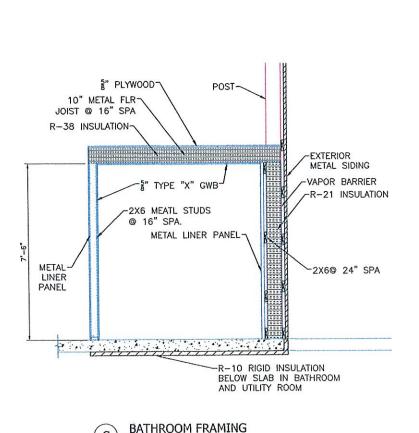

Scale: 1/2":1ft

ON DEMAND-

WATER HEATER

WATER METER-3" BACKFLOW

FD-

PVC:

7'-01/4"


PLUMBING LAYOUT



1" WATER

SERVICE

4" SANITARY LATERAL @

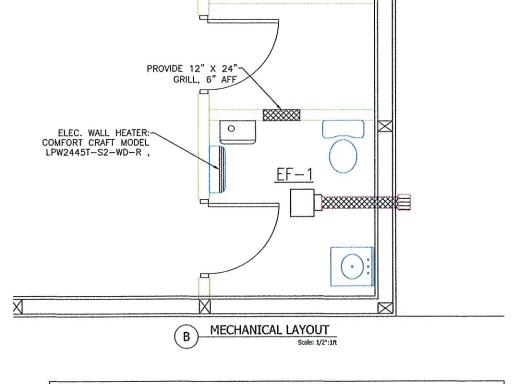


				EXHAU:	ST FAN	N SCHED	ULE			
MINIDED	DDIVE	SERVICE	CFM	FM SP RPM		SP ELECTRICAL		L	MAKE (MODE)	NOTES
NUMBER	DRIVE	DRIVE SERVICE CFM IN WG	RPM	VOLTS	PH.	WATTS	MAKE/ MODEL			
EF-1	DIRECT	DRESSING ROOM	110	.10	950	115	1	80W	GREENHECK SP-B110	1-2

- 1. FURNISH COMPLETE WITH GREENHECK #WC WALL CAP
 2. INTERLOCK FAN OPERATION WITH LIGHTING CONTROL
 3. INTERLOCK FAN OPERATION WITH WALL MOUNTED THERMOSTAT

			ELE	CTRIC	WAL	L HE	ATER	
MINADED	SUPPLY	WATTS	AMPS	ELE	CTRI	CAL	LINE MODEL	NOTES
NUMBER	AIR (CFM)	WALIS	AMPS	VOLTS	PH.	HZ	MAKE/MODEL	Mores
EH-1	185	3,500	9.4-18.8	208	1	60	COMFORT CRAFT MODEL LPW445T-S2-WD-R	1

- NOTES:
 1. FURNISH COMPLETE WITH LOW AMBIENT KIT
- 2. PROVIDE 6" (MIN) CONCRETE PAD FOR CONDENSER

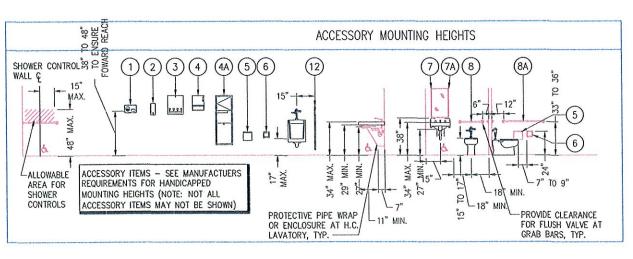

ANDREW	11142 ALEXA	(28
MECH/PLUMBING PLAN	STORAGE / RETAIL BUILDING 111 CEDAR ST., BATAWA, NY	CEDAR STREET SALES 151 CEDAR STREET, BATAVIA, NY

DATE

¥

ROAD, ATTICA, 97-3552

ALEXANDER F (585) 297

SCHMIEDER, PE

PROJECT NO.:	PROJ. MGR
005-2019	ADS
DATE: 4-15-19	DRWN. BY:
SCALE:	CHKO, BY:
AS NOTED	ADS
DRAWING NO: M-1	
SHEET NO.	
16 °	f 16



City of Batavia Department of Public Works Bureau of Inspections

One Batavia City Center, Batavia, New York 14020

(585)-345-6345

(585)-345-1385 (fax)

To:

Zoning Board of Appeals

From:

Doug Randall, Code Enforcement Officer

Date:

4/29/19

Re:

43 Vernon Ave.

Tax Parcel No. 84.023-2-13

Zoning Use District: R-1A

The applicant, Charles Kohorst (contractor/agent for owner), has filed an application to remove an existing open porch and construct a new enclosed front porch with stairs and landing under an existing roof. Portions of the new structure will be located within the front yard clear space.

Note: This is a type II action as defined by Environmental Conservation Law and is not subject to review under SEQR 6 NYCRR Part 617.5 (c) (10).

Review and Approval Procedures:

Zoning Board of Appeals- Pursuant to BMC Sec. 190-49 of the zoning ordinance, the ZBA shall review and act on required variances.

1) Required variances- Area

BMC Sec. 190-29 A. and Schedule I

	<u>Required</u>	Proposed	<u>Difference</u>
Front yard clear space	20'	14.03	5.97'

Received
APR 2-6 2019

CITY OF BATAVIA


APPLICATION TO THE ZONING BOARD OF APPE	ALS City of Batavia	
	Inspection Buleau	
MAY 2 0 2019 Application No.: Heaving Date/Time	1-04	
Hearing Date/Time	:	
CITY OF BATAVIA CITY OF BATAVIA	1	
APPLICANT: Charles Kohor	st Qyahoorcom	
Name E-Mail Address	- 1	
922 Genesee St. 585-409-0881 Street Address Phone	Fax	
Corfu N. y.	14036	
City State	Zip	
STATUS: Agent for Owner	Contractor	
OWNER: Richard and Mary Blevins		
Name E-Mail Address	•	
43 Vernon Ave.		
Street Address Phone.	Fax 4036	
City State	Zip ,	
LOCATION OF PROPERTY: 43 Vernon Ave.	ė, l	
	•	
DETAILED DESCRIPTION OF REQUEST: To rebuild enclose	d Porch	
that is sinking. Remove existing forch and rebuild		
That is streng of temore existing forch and rebailed		
new Enclosed porch to drawing using 6x6 Posts		
7'6" O.C. 2x8 floor joist, 2x6 walls, 3/4" Subfloor OSB, R19:non Vator		
Applicant must be present at the hearing date. Failure to do so will result in the application being discarded. It is the responsibility of the applicant to present evidence sufficient to satisfy the Zoning Board of Appeals that the benefit of the applicant does not outweigh the health, safety, morals, aesthetics and general welfare of the community or neighborhood.		
04/25/20	2/0	
	47	
Applicant's Signature Date		
	(
Owner's Signature Date		
Owner, a dignature	,	
1 8		
To be Filled out by Zoning Officer		
TAX PARCEL: 84.053-2-13 ZONING DISTRICT: R-IA FLOOD PLAIN: C		
TYPE OF APPEAL: Area Variance FEE: V\$50 (One or Ty	No Family Use)	
	CONTROL OF THE CONTRO	
Interpretation		
Decision of Planning Committee		
Provision(s) of the Zoning Ordinance Appealed: 190-29 A. and Schedolo -	- Frontyard	
Clear 5 mcx 15 20'		
	2.00 CH2 CH4 CH2	

Criteria to Support Area Variance

In making its determination, the zoning Board of Appeals shall take into consideration the benefit to the applicant if the variance is granted, as weighed against the detriment to the health, safety, moral, aesthetics and welfare of the neighborhood or community. The Zoning Board of Appeals shall consider the following test, as per §81-b of the General City Law when making its determination:

Explain how the proposal conforms to EACH of the following requirements:

1.	Undesirable Change in neighborhood Character. The granting of the variance will not produce an undesirable change in the neighborhood or a detriment to nearby properties. It is an entrance landing to enter enclosed porch and will be in line with other ones that already exist on the Street.	
	porch and will be in line with other ones that	
	already exist on the Street.	
2.	Alternative Cure Sought. There are no other means feasible for the applicant to pursue that would result in the difficulty being avoided or remedied, other than the granting of the area variance. The only other place to put if would bring it out into the driveway.	
^	Substantiality. The required even variance is not substantial.	
3.	3. <u>Substantiality</u> . The requested area variance is not substantial. <u>Seek</u> to do a minimal size landing with stars to enterence enclosed porch.	
	a minimal size landing with stairs to enter	
	enclosed porch,	
4,	Adverse Effect or Impact. The requested variance will not have an adverse effect or impact on the physical or environmental condition in the neighborhood or community.	
5.	Not Self-Created. The alleged difficulty existed at the time of the enactment of the provision or was created by natural force or governmental action, and was not the result of any action by the owner or the predecessors in title.	
_	O9/25/2019	
A	oplicant's Signature Date	

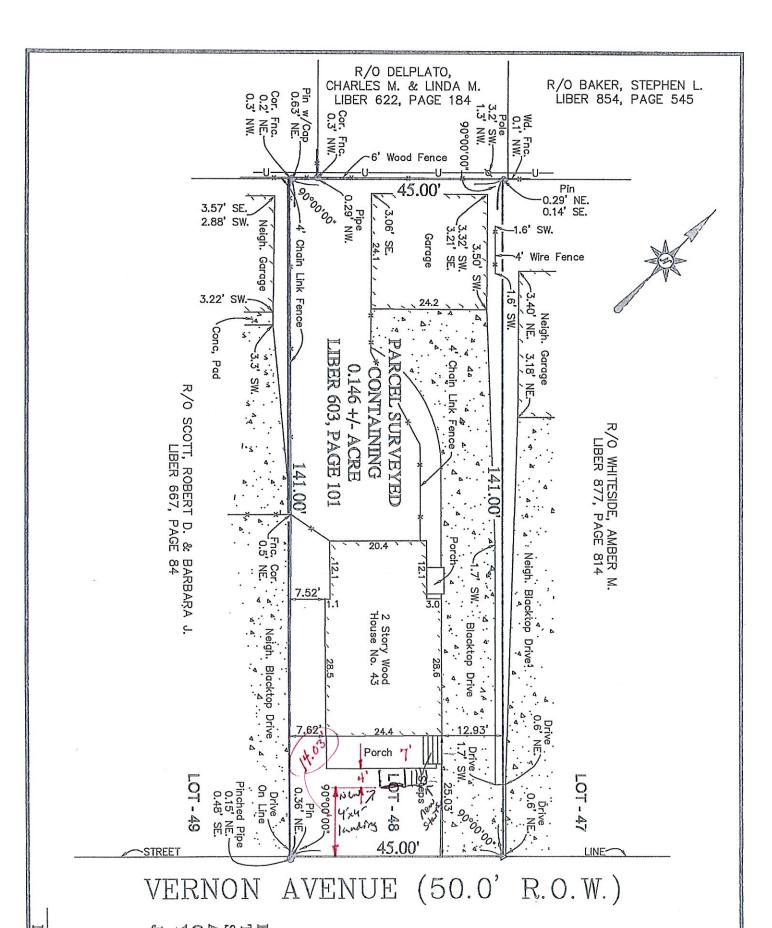

TO I SUBI ADDI COUI YORI

- × 0 ×

Existing House Enclosed Porch Rebuild 23′ 亡 Estairs

14"=1"

